SITE AND BUILDING DATA BLOCK No. 228 LOT No.. ZONE

TYPE OF CONSTRUCTION 5-B AREA OF SITE 34.19 acres (1,489,316 S.F.)

AREA OF BUILDING

320 S.F. BASEMENT FIRST FLOOR 320 S.F. <u> 200 S.F</u>. SECOND FLOOR 550 S.F. SITE: COVERAGE:

LIVE LOADS

30 P.S.I. ROOF ATTIC 20 P.S.I. 40 P.S.I. FLOOR

0.03 %

2 STORIES

20'-4" MAX. BLDG. HT. R-3 BUILDING USE GROUP BUILDING VOLUME 40,486 CU. FT. 3 OCCUPANTS MAX. OCCUPANT LOAD

<u>GENERAL CONDITIONS</u>

THE LATEST EDITION OF AIA DOCUMENT A201. "GENERAL CONDITIONS OF THE CONTRACT FOR CONSTRUCTION" ARE HEREIN PART OF THE CONTRACT FOR ALL TRADES. SECTION 4.1.I. THROUGH 4.2.2, 4.2.4 THROUGH 4.2.13 AND 9.1.1 THROUGH 9.9.3 ARE HEREBY OMITTED FROM THIS PROJECT. THE ARCHITECT SHALL NOT PERFORM ADMINISTRATION OF THE CONTRACT (FIELD OBSERVATIONS, ETC.) DURING CONSTRUCTION.

GENERAL NOTES:

- I) ALL WORK PERFORMED SHALL COMPLY WITH THE N.J.U.C.C., LATEST EDITION AND ALL OTHER LOCAL CODES AND ORDINANCES THAT APPLY.
- 2) THE GENERAL CONTRACTOR (G.C.) AND HIS SUBCONTRACTORS SHALL VERIFY ALL CONDITIONS, DIMENSIONS, ETC. AT THE SITE AND SHALL REPORT ANY DISCREPANCIES TO THE ARCHITECT IN WRITING PRIOR TO CONSTRUCTION. COMMENCEMENT OF WORK IMPLIES THE ACCEPTANCE OF ALL CONDITIONS. G.C. SHALL ALSO COORDINATE HIS WORK WITH

WORK OF ALL OTHER TRADES. 3) THE INTENT OF THE DRAWINGS AND SPECIFICATIONS IS TO INCLUDE ALL ITEMS NECESSARY FOR THE PROPER EXECUTION AND COMPLETION OF WORK, ALL WORK THAT IS REASONABLE INFERABLE AS BEING NECESSARY TO PRODUCE THE INTENDED RESULT IS REQUIRED, WHETHER SPECIFICALLY SHOWN IN DRAWINGS OR SPECIFICATIONS, OR NOT. THE OWNER AND CONTRACTOR SHALL DECIDE AND AGREE UPON PRODUCTS, MANUFACTURES, COLORS, STYLES, HARDWARE, TEXTURES, ETC. UNLESS OTHERWISE NOTED ON THE

DRAWINGS. 4) FIRE INSURANCE WITH EXTENDED COVERAGE: UNTIL A CERTIFICATE OF OCCUPANCY IS OBTAINED, THE CONTRACTOR SHALL INSURE THE BUILDING AND WORK INCLUDED IN THIS CONTRACT AGAINST LOSS OR DAMAGE BY FIRE AND AGAINST LOSS OR DAMAGE COVERED BY THE STANDARD EXTENDED COVERAGE INSURANCE ENDORSEMENT, IN AN INSURANCE COMPANY ACCEPTED BY THE OWNER. THE AMOUNT OF INSURANCE AT ALL TIMES TO BE AT LEAST EQUAL TO THE AMOUNT PAID ON ACCOUNT OF WORK AND MATERIALS PLUS THE VALUE OF WORK AND MATERIALS FURNISHED OR DELIVERED BUT NOT YET PAID FOR BY THE OWNER. THE POLICIES SHALL BE IN THE NAME OF THE OWNER AND CONTRACTOR, AS THEIR INTERESTS MAY APPEAR AND CERTIFICATE OF INSURANCE COMPANY AS TO THE AMOUNT AND TYPE OF COVERAGE, TERMS, AND POLICIES, ETC., SHALL BE DELIVERED TO THE OWNER BEFORE PARTIAL PAYMENTS ARE MADE.

5) CONTRACTOR'S LIABILITY INSURANCE: a) WORKMAN'S COMPENSATION- MIN OF \$5000,000 EA. ACCIDENT

b) COMPREHENSIVE GENERAL LIABILITY i) PERSONAL INJURY-EACH PERSON- \$5000,000

EACH OCCURRENCE- \$1,000,000

I. PROPERTY DAMAGE-EACH OCCURRENCE - \$250,000

a. CONTINUED COVERAGE IN FORCE FOR ONE YEAR AFTER COMPLETION OF WORK b. COMPREHENSIVE AUTO LIABITLIY (INCLUDED HIRE COVERAGE AS MELL AS OMNED) i. EACH PERSON -\$500,000

ii. EACH OCCURRENCE-\$1,000,000 6) G.C SHALL PROVIDE ALL PROTECTION MEASURES FOR THE SAFETY OF THE PUBLIC,

AND WORKMAN DURING THE COURSE OF THE WORK. 7) ALL WORK ON THIS PROJECT SHALL BE DONE IN THE BEST WORKMAN LIKE MANNER. 8) G.C. SHALL OBTAIN AND PAY FOR ALL PERMITS AND CERTIFICATE OF OCCUPANCY.

9) SITE WORK SHALL INCLUDE THE FOLLOWING: a) CLEAR SITE AS REQUIRED FOR NEW CONSTRUCTION OR AS INDICATED ON THE DRAWINGS.

b) ROUGH GRADE TO REQUIRED ELEVATIONS.

c) REMOVE ALL DEBRIS AT PROJECT COMPLETION. d) ALL GRADING SHALL MAINTAIN POSITIVE DRAINAGE AWAY FROM THE BUILDING

FOUNDATION.

e) <u>Blacktop driveway</u>: Subgrade shall be well drained, uniformly graded and COMPACTED. BAE COURSE SHALL BE A MIN. OF 4" THICK GRAVEL. WEARING COURSE SHALL BE MIN. 2" THICK ASPHATIC CONCRETE. EXTEND DRIVEWAY FROM GARAGE TO STREET WITH ENTRANCE FLARED FOR SAFE ACCESS

IO) SUBGRADE SOIL AT CONCRETE CONSTRUCTION AND BACKFILL AT STRUCTURE SHALL BE CONSOLIDATED AND COMPACTED TO A MINIMUM DENSITY OF 95% OF THE MAXIMUM ATTAINABLE DENSITY. SUBGRADE SOIL FOR FILL SHALL BE CONSOLIDATED AND COMPACTED TO A MINIMUM DENSITY OF 90% OF THE MAXIMUM ATTAINABLE DENSITY. THE SUBGRADE FOUNDATION MATERIAL FOR BACKING SHALL CONSIST OF SAND OR SAND

GRAVEL MIXTURE. II) FILL AND BACKFILL: EXCEPT AS OTHERWISE SPECIFIED, FILL AND BACKFILL SHALL CONSIST OF SUITABLE EXCAVATED MATERIALS. CONSISTING OF EARTH, SANDY CLAY, SAND AND GRAVEL, SOFT SHALL OR OTHER APPROVED MATERIALS. NOTE: FOUNDATION WALLS SHALL NOT BE BACKFILLED UNLESS FRAMING IS COMPLETE OR ADEQUATE TEMPORARY SHORING IS INSTALLED.

12) DRAWINGS ARE NOT TO BE SCALED OFF UNDER ANY CIRCUMSTANCES. ANY DIMENSIONAL DISCREPANCIES FOUND SHALL BE REPORTED TO THE ARCHITECT BEFORE MORK IS TO CONTINUE.

REQUIRED FOR COMPLETION OF THE PROJECT. REMOVE FROM THE E PREMISES ALL DEMOLISHED MATERIAL NOT DESIGNATED FOR REUSE AND DISPOSE OF IN STRICT ACCORDANCE WITH LOCAL AND STATE CODES. LEAVE THE PREMISES CLEAN, NEAT AND ORDERLY AT THE COMPLETION OF THE PROJECT 14) ALL MATERIALS FOR THIS PROJECT SHALL BE NEW AND UNDAMAGED UNLESS

I3) DEMOLITION CONTRACTOR SHALL BE RESPONSIBLE FOR ALL DEMOLITION AS

OTHERWISE NOTED ON DRAWINGS.

15) ALL KITCHEN CABINET WORK INCLUDING KITCHEN CABINETS, BATHROOM VANITIES AND APPLIANCES WILL BE FURNISHED AND INSTALLED BY OTHERS. G.C., ELECTRICAL CONTRACTOR, AND PLUMBING CONTRACTOR SHALL COORDINATE THEIR WORK WITH THE CABINET CONTRACTOR FOR REQUIRED WORK.

16) THE OWNER SHALL FURNISH ALL BATH ACCESSORIES, INCLUDING MIRRORS, MEDICINE CABINETS, TISSUE DISPENSERS, TOWEL BARS, ETC. G.C. SHALL INCLUDE IN HIS PRICE THE COST TO INSTALL ALL ACCESSORIES. COORDINATE LOCATIONS, REQUIREMENTS FOR RECESSED ACCESSORIES, CONCEALED WALL REINFORCEMENT, ETC., WITH OWNER.

I) BOTTOMS OF EXTERIOR FOOTINGS SHALL BE A MINIMUM OF 3'-O" BELOW THE FINISHED GRADE AND TO FIRM UNDISTURBED SOIL UNLESS OTHERWISE NOTED. 2) ALL CONCRETE METHODS, MATERIALS AND WORKMANSHIP TO BE IN ACCORDANCE WITH

ACI 318, LATEST EDITION. 3) ALL CONCRETE FOR FOOTINGS SHALL HAVE A STONE AGGREGATE AND ATTAIN A MINIMUM COMPRESSIVE STRENGTH OF 300 PSI AT 28 DAYS. CONCRETE EXPOSED TO THE WEATHER, I.E. WALKS, PATIOS, ETC. ATTAIN A MINIMUM COMPRESSIVE STRENGTH OF 4,500 PSI @ 28 DAYS.

4) POROUS FILL UNDER CONCRETE SLABS WALKS, ETC. TO CONSIST OF CLEAN CRUSHED STONE OR CRUSHED GRAVEL.

5) EXPANSION JOINTS TO BE KEYED AND COATED WITH MASTIC BEFORE PLACING ADJACENT TO CONCRETE.

6) STEEL TROWEL FINISH ALL INTERIOR CONCRETE SLABS. 7) BROOM NON-SLIP FINISH ALL EXTERIOR CONCRETE SLABS.

8) ALL REINFORCEMENT BARS SHALL CONFORM TO ASTM A615 LATEST EDITION. 9) ALL FRAMING LUMBER SHALL BE DOUGLAS FIR No.2 WITH A MINIMUM FB=1450 PSI EXTREME FIBER IN BENDING AND A MODULUS OF ELASTICITY OF E=1,700,000 10) EXTERIOR TERRACE FRAMING LUMBER SHALL BE PRESSURE TREATED No.1 WITH GALVANIZED NAILS, BOLTS, ETC.

II) WOOD PLATES THAT BEAR DIRECTLY ON MASONRY SHALL BE PRESSURE TREATED. 12) PLYWOOD FOR CARPETING AND RESILIENT FLOORS SHALL BE UNDERLAYMENT GRADE

13) DOUBLE-UP FLOOR JOISTS WITH 2"X4" VERTICAL SPACER BETWEEN AT 24" O.C. BENEATH ALL PARALLEL PARTITIONS.

14) DOUBLE-UP ROOF AND CEILING FRAMING ALL AROUND OPENINGS FOR SKYLIGHTS, CHIMNEY PENETRATIONS, ETC. 15) MAINTAIN 2" CLEARANCE BETWEEN FRAMING AND CHIMNEYS

16) PROVIDE 5/4 x3 MOOD CROSS BRIDGING FOR ALL JOISTS AT A MAXIMUM SPACING OF 8'-O" O.C. IT) ALL JOISTS AND RAFTERS REQUIRING FLUSH CONNECTIONS SHALL RECEIVE

APPROPRIATE FRAMING ANCHORS AS MANUFACTURED BY SIMPSON STRONG TIE OR EQUAL (OR AS SPECIFICALLY DETAILED ON DRAWINGS) 18) PROVIDE 2-2"x12" HEADERS OVER ALL EXTERIOR WALL OPENINGS AND INTERIOR DOOR OPENINGS UNLESS OTHERWISE NOTED.

19) PROVIDE BEARING PLATES WITH ANCHORS FOR ALL STEEL BEAMS BEARING ON MASONRY AS NOTED OR DETAILED. 20) PROVIDE A MINIMUM OF 2-3/4" x 18" LONG ANCHOR BOLTS WITH 3" HOOK FOR ALL

COLUMNS. SETTING PLATES SHALL BE 1/2" THICK. 21) ALL FLITCH BEAMS SHALL BE THROUGH-BOLTEED WITH 1/2" DIAMETER CARRIAGE BOLTS AT 18" O.C. STAGGERED ROWS TOP AND BOTTOM

I) ROOF SHEATHING: I/2" THICK C-D INT APA WITH EXTERIOR GLUE. MAX. SPAN 24" MAX. UNSUPPORTED EDGE, 24"

2) WALL SHEATHING: 1/2" THK. C-D INT-APA WITH EXTERIOR GLUE 3) SUBFLOORING: 1/2" THK. C-D INT APA WITH EXTERIOR GLUE. MAX SPAN 16" O.C. NAILING: 6D COMMON 6" O.C. AT EDGES AND IO" O.C. AT INTERMEDIATE POINTS 4) UNDERLAYMENT - 1/4" THK. UNDERLAYMENT INT-APA WITH EXTERIOR GLUE 5) APPLICATION SHALL BE IN ACCORDANCE WITH THE LATEST ADDITION OF THE AMERICAN

PLYWOOD ASSOCIATION.

I) CONRETE MASONRY UNITS SHALL COMPLY WITH THE FOLLOWING: a. HOLLOW UNITS: ASTM C 09

b. SOLID UNITS: ASTM C145 c. BLOCK SHALL HAVE A MIN. COMPRESSIVE STREGNTH OF 1,000 PSI 2) USE GRADE N-I CONCRETE MASONRY UNITS FOR FOUNDATIONS FOR EXTERIOR USE. USE GRADE S-1 FOR BACK-UP OR INTERIOR NON-LOADING BEARING WORK.

3) MORTARS: COMPLY WITH ASTM C 270 MASONRY AND MORTAR TYPES a. MASONRY MOTAR-EXTERIOR: TYPE S

b. MASONRY MORTAR-INTERIOR: TYPE N. c. SETTING BED MORTAR AND GROUT: TYPE M d. FIRE BRICK REFRACTORY AIR SETTING MORTAR

e. PREPARATION OF MORTAR IN ACCORDANCE WITH BOCA TABLE III4.2.I MASONRY IN

CONTACT WITH EARTH: TYPE M OR S. 4) INSTALL MASONRY UNITS PLUMB AND TRUE TO LINE IN REGULAR BOND, IN DULL BED OF MORTAR WITH JOINTS UNIFORM IN THICKNESS. ALL EXPOSED JOINTS SHALL BE WELL TOOLED. REINFORCED HORIZONTAL JOINTS WITH 9 GUAGE WELDED STEEL WIRE EVERY 16' VERTICALLY. UNLESS OTHERWISE NOTED ALL WORK SHALL BE IN RUNNING BOND. MASONRY SHALL BE PROTECTED FROM FREEZING FOR NOT LESS THAN 46 HRS AFTER INSTALLATION. 5) MASONRY FOUNDATIONS: CONTRACTOR SHALL COPRDINATE TOPS OF MASONRY WITH FLOOR FRAMING. ARCHITECTURAL REQUIREMENTS AND FINISH GRADES. ALL MASONRY WALLS SHALL BE LATERALLY SUPPORTED BY HORIZONTAL BRACING OF FLOOR AND ROOF FRAMING. SILL PLATES SHALL BE ANCHORED WITH 1/2" DIAM. BOLTS EXTENDING 16" INTO FILLED CELLS OF THE MASONRY UNITS. SPACING OF BOLTS SHAL BE 48" O.C. WITH NO MORE THAN 12" OF ANY END OF PLATE. PROVIDE AT LEAST 2 BOLTS PER PLATE. ENDS OF FLOOR JOISTS SHALL BE ANCHORED EVERY 4TH JOIST WITH TRIP-L-GRIP OR SIMPSON ANCHORS. JOISTS PARALLEL TO ADJACENT WALSS SHALL BE ANCHORED TO MASNORY WALL AT INTERVALS NOT TO EXCEED 8'-O" WITH I-I/2" x I/4" BENT STEEL ANCHORS. ONE END SHALL BE EMBEDDEDIN MORTAR JOINT OR END BENT DOWN INTO MOTAR FILLED BLACK CORE. LENGTH OF ANCHOR SHALL BE SUFFICIENT TO ENGAGE AT LEAST 3 JOINTS. 6) BRICK: SHALL COMPLY WITH ASTM STANDARDS AS FOLLOWS

a. SOLID UNITS OF FACE BRICK- C 216 b. SOLID UNITS OF BUILDING BRICK - C 26 c. GRADE REQUIREMENTS FOR UNITS IN CONTACT WITH GROUBD OR SUBJECT TO WATER, FROST, AND FREEZING SHALL COMPLY WITH PROVISIONS OF ASTM.

d. WETTING OF BRICK SHALL BE REQUIRED IF THE UNITS INTIAL RATE OF ABSORBTION

ECEEDS 0.035 OUNCES PER SQUARE INCH e. METAL TIES FOR BRICK VENEER SHALL BE 22 GA. MIN. GALV. CORRUGATED STEEL, 7/8" MIN. WIDTH TIES SHALL BE NAILED TO STUDS AND SPACED 16" O.C. VERT. AND 32" O.C. HORIZ. (MAX.)

MICRO-LAM BEAM:

I) <u>SCOPE OF WORK:</u> ALL STRUCTURAL MICRO-LAM LVL LUMBER SHALL BE FURNISHED AS SHOWN DETAILED ON THE PLANS AND SPECIFIED HEREIN

2) MANUFACTURE: MATERIALS, MANUFACTURE AND QUALITY CONTROL SHALL IN CONFORMANCE WITH THE STANDARDS OF THE "TRUSS JOISTS YSTEM CORPORATION". BEAMS SHALL PROVIDE THE FOLLOWING ALLOWABLE STRESS VALUES: a) 2800 PSI EXTREME FIBER STRESS IN BENDING (FB), 2600 PSI TENSION PARALLEL TO

GRAIN (FT), 500 PSI COMPRESSION PERPENDICULAR TO GRAIN PARALLEL TO GLUE LINE (FC), 2400 PSI COMPRESSION PARALLEL TO GRAIN (FCII, AND 250 PSI HORIZONTAL SHEAR PERPENDICULAR TO GLUE LINE (FV).

3) INSTALLATION: WHERE MULTIPLE UNIT BEAMS ARE SPECIFIED, THE BEAMS SHALL BE THROUGH-BOLTED WITH I/2" DIAMETER CARRAIGE BOLTS AT 24" O.C. STAGGERED ROWS TOP AND BOTTOM.

FINISH NOTES 1) WALLS AND CEILINGS: STANDARD GYPSUM BOARD USED FOR ALL FACING LAYERS OF ALL COUNTERTOPS, THE STANDARD MOUNTING HEIGHT SHALL BE 42" A.F.F. THE STANDARD PARTITIONS AND CEILINGS, 48" WIDE AND 1/2" UNLESS OTHERWISE NOTED, WITH TAPERED BEVELED EDGES AND ATTACHED WITH SCREWS IN ACCORDANCE WITH MANUFACTURE'S SPECIFICATIONS. ALL GYPSUM BOARD SHALL RECEIVE A 3-COAT SPACKLE FINISH. ALL

SPACKLE WORK SHALL BE FINE SANDED SMOOTH AND LEVEL. 2) PAINTING AND FINISHING OF ALL INTERIOR AND EXTERIOR ITEMS SHALL BE AS FOLLOWS: (COLOR AND GLOSS TO BE SELECTED BY THE OWNER.) ALL SURFACES TO BE PAINTED SHALL BE CLEANED PROPERLY PREPARED IN ACCORDANCE WITH THE MANUFACTURES INSTRUCTIONS. PROTECT ADJACENT SURFACES AS REQUIRED.

3) DRAFTSTOP ALL SOFFITS AS FOLLOWS: a) CONSTRUCT SOFFIT AFTER GYPSUM BOARD WALLS AND CEILINGS HAVE BEEN COMPLETED. FIRE-TAPE ALL CONCEALED JOISTS. SEAL AROUND ALL PENETRATIONS FOR PIPING/WIRING. b) ALL BATT INSULATION SHALL HAVE INTEGRAL FOIL VAPOR BARRIER UNLESS OTHERWISE

4) ALL CLOSETS TO BE FURNISHED WITH A FINISHED WOOD SHELF AND A STAINLESS STEEL POLE, UNLESS OTHERWISE NOTED. 5) WHERE FLOOR FINISHES OF DIFFERENT ELEVATION MEET, PROVIDE APPROPRIATE REDUCING 6) WHERE WALLS AND/OR CEILINGS MEET AND AN ANGLE OTHER THAN 90 DEG. OCCURS, THE

JOIN SHALL BE FINISHED WITH "BEADEX" B-I FLEX BEAD OR IT'S APPROVED EQUIVALENT. SPACKLE AND SMOOTH AND LEVEL 7) PROVIDE STANDARD CORNER BEADS ON ALL 90 DEG. INTERSECTIONS. USE PLASTIC CORNER BEADS IN BATH AREAS

8) ALL CERAMIC FLOOR TILE SHALL BE THIN SET OVER 1/4" THICK PORTLAND CEMENT/SANF BASE REINFORCED WITH GALVANIZED METAL LATH OVER #15 BUILDING FELT ON 5/8" EXTERIOR GRADE PLYWOOD SUBFLOOR.

9) WHERE CERAMIC TILE IS INDICATED AS A WALL OR CEILING FINISH IN TUB OR SHOWER ENCLOSURES, THE SUBSTRATE SHALL BE 1/2" WONDER BOAR. IN ALL OTHER AREAS, SUBSTRATE SHALL BE 1/2" MOISTURE RESISTANT GYPSUM BOARD.

THERMAL AND MOISTURE PROTECTION

I) INSULATION: SPRAY FOAM INSULATION BY CARISLE OR APPROVED EQUAL MAINTAIN R- VALUES AS LISTED BELOW

a) EXTERIOR WALLS: R-30 b) ROOF AND CEILING OVER UNHEATED SPACES: R-49 c) FLOORS AND CEILINGS OVER HEATED SPACES: R-30

I) STANDING SEAM METAL PANEL SYSTEM BY NUCOR OR APPROVED EQUAL. SHALL BE INSTALLED OVER #30 FELT. INSTALL ROOFING OVER ICE AND WATER BARRIER (GAF "WEATHER WATCH") AT EAVES AND VALLEYS.

3) ICE AND WATER SHIELD: PROVIDE 0.040" THICK BY 36" ICE AND WATER SHIELD ROOFING UNDERLAYMENT. PRODUCT IS COMPOSED OF POLYOLEFIN FILM LAMINATED TO RUBBER ASPHALT AND MANUFACTURED BY W.R. GRACE PREPARE SUBSTRATE AND INSTALL IN STRICT ACCORDANCE WITH MANUFACTURE'S DETAILS AND INSTALLATION INSTRUCTIONS

<u> WINDOWS:</u>

I) "PERMA SHIELD" WOOD WINDOWS AS MANUFACTURED BY THE ANDERSON CORPORATION 200 SERIES . SIZES AND TYPES SHALL BE INDICATED ON THE PLANS. THE OWNER SHALL SELECT COLOR OF THE PERM SHIELD CLADDING. GLAZING SHALL BE HIGH PERFORMANCE INSULATING. REFER TO FLOOR PLANS FOR UNITS REQUIRING EGRESS HARDWARE.

2) TEMPERED GLASS SHALL BE INSTALLED WHERE INDICATED ON THE PLANS. 3) FURNISH AND INSTALL WITH THE FOLLOWING ACCESSORIES:

a) INSECT SCREEN FOR OPERABLE SASH UNITS b) EXTENSION JAMBS, MULLION COVERS (INTERIOR AND EXTERIOR), CLIPS, FLASHINGS

ETC. AS REQUIRED FOR COMPLETE INSULATION.

 ALL WORK SHALL COMPLY WITH THE NATIONAL STANDARD PLUMBING CODE, ADOPTED AND AMENDED BY THE N.J.U.C.C. 2) ALL WATER SUPPLY LINES SHALL BE COPPER, TYPE L. ALL SOLDER USED SHALL

3) SHOWER CONTROLS SHALL HAVE PRESSURE BALANCE VALVE AND INTEGRAL VALVE STOPS.

4) ALL HOT WATER LINES, CONCEALED OR NOT, SHALL BE INSULATED WITH A 1/2" ARMAFLEX OR EQUAL. 5) ALL WASTE LINES MAY BE PVC SCH4O. WHERE PVC IS INSTALLED IN WALLS OR FLOORS, PROVIDE INSULATION BATTS AROUND PIPES TO REDUCE SOUND

6) PLUMBING FIXTURES AND TRIM SHALL BE AS SELECTED BY THE OWNER AND INSTALLED BY THE G.C.

7) HOT WATER HEATER: 50 GAL. GAS FIRED AS MANUFACTURED BY RHEEM OR EQUAL

I) ALL WORK SHALL BE IN ACCORDANCE WITH THE BOCA MECHANICAL CODE LATEST EDITION, NATIONAL FIRE PROTECTION ASSOCIATION AND REFRIGERATION SAFETY

CODE ASHAE. 2) G.C. SHALL PROVIDE A HEATING, VENTILATING AND AIR-CONDITIONING SYSTEM AS REQUIRED TO MEET THE FOLLOWING DESIGN CONDITIONS: a) HEATING: OUTSIDE O DEG. F- INSIDE TO DEG. F

b) COOLING: OUTSIDE 95 DEG. F DB/78 DEG. WB - INSIDE 72 DEG. DB/60 DEG. WB. THE HAVE SYSTEM SHALL BE AS FOLLOWS:

GROUND FLOOR UPPER FLOOR

I. HEATING: HOT AIR FURNACE SYSTEM ZONED AS FOLLOWS 2. COOLING: HIGH EFFICIENCY AIR HANDLERS WITH REMOTE HIGH EFFICIENCY CONDENSERS (SPLIT SYSTEM) AND ELECTRONIC FILTERS, ZONED AS FOLLOWS: ALL EQUIPMENT SHALL BE MANUFACTURED BY RUUD, CARRIER, OR LENNOX

4) COORDINATE CONTROL AND POWER WIRING REQUIREMENTS WITH ELECTRICAL CONTRACTOR IN FIELD. 5) COORDINATE LOCATION OF HVAC EQUIPMENT IN FIELD WITH THE OWNER IF NOT 6) PROVIDE ELECTRONIC THERMOSTATS, HONEYWELL OR EQUAL, FOR EACH ZONE.

T-STATS SHALL BE ELECTRONIC TYPE WITH PROGRAMMABLE NIGHT SETBACK, HONEYWELL OR EQUAL

ELECTRICAL NOTES: L WORK SHALL BE IN ACCORDANCE WITH THE NATIONAL ELECTRIC CODE, LATEST

2) SCOPE OF WORK: FURNISH ALL LABOR, MATERIAL AND APPLIANCES IN ORDER TO PRODUCE A COMPLETE ELECTRICAL SYSTEM. CONTRACT SHALL INCLUDE, BUT NOT BE LIMITED TO THE FOLLOWING PRINCIPAL ITEMS OF WORK:

b) ELECTRICAL MAIN AND BRANCH PANELS AS REQUIRED. c) WORK IN CONNECTION WITH TRADES.

d) INSTALLATION OF LIGHTING FIXTURES WITH LAMPS, DOOR CHIMES, ETC. e) DEVICE PLATES

f) TEMPORARY LIGHT AND POWER

a) PROVIDE NEW SERVICE.

a) TAGGING OF FEEDERS 3) G.C SHALL SECURE AND PAY FOR ALL PERMITS AND INSPECTIONS. PROVIDE OWNER WITH CERTIFICATES OF INSPECTIONS.

4) ALL WIRING SHALL BE COPPER TYPE AC (ARMORED CABLE) OR NM (NONMETTALIC CABLE). OUTLET BOXES SHALL BE TYPE AND SIZES FOR ALL LOCATION USE INTENDED.

5) COORDINATE CONTROL AND POWER WIRING REQUIREMENTS FOR HVAC EQUIPMENT WITH MECHANICAL CONTRACTOR. 6) WHERE OUTLETS ARE SHOWN TO BE CONTROLLED BY SWITCHED, CONNECT SWITCH


TO TOP LEG OF OUTLET ONLY. VERIFY LOCATION WITH OWNER. 7) SMOKE DETECTORS TO BE HARD WIRED AND INTER-CONNECTED. SYSTEM SHALL BE FURNISHED AND INSTALLED WITH A BATTERY BACK-UP. 8) ALL LIGHTING FIXTURES SHALL BE FURNISHED BY THE OWNER (B.O.) WIRED AND INSTALLED BY THE ELECTRICAL CONTRACTOR, UNLESS OTHERWISE NOTED. ALL

FIXTURES SHALL BE CAPABLE OF USING 'A' TYPE LAMPS. 9) EXHAUST FANS (E.F.) SHALL BE AS MANUFACTURED BY 'BRAON' OR EQUAL, AND SHALL INCLUDE A BUILT-IN LIGHT (UNLESS OTHERWISE NOTED), DUCT TO THE EXTERIOR SUPPLIED AND INSTALLED BY THE ELECTRICAL CONTRACTOR. IO) VERIFY THE FINAL LOCATION OF ALL SMITCHES, OUTLETS, LIGHTING FIXTURES ETC.,

WITH THE OWNER PRIOR TO COMMENCING WITH THE WORK. II) SMITCHED SHALL BE SILENT TOGGLE TYPE (DIMMERS SHALL BE SLIDING TYPE) 12) OUTLETS SHALL BE DUPLEX GROUNDING TYPE.


13) ALL DEVICES SHALL BE U.L. LISTED AS MANUFACTURED BY 'LEVITON' OR 'EAGLE'. COLOR AS SELECTED BY THE OWNER. 14) THE STANDARD MOUNTING HEIGHT OF ALL OUTLETS SHOWN SHALL BE 16" A.F.F.

MEASURED TO CENTERLINE. WHERE OUTLETS ARE SHOWN TO BE LOCATED ABOVE MOUNTING HEIGHT OF ALL SMITCHES SHALL BE 48" A.F.F. MEASURED TO THE CENTERLINE. REFER TO DRAWINGS FOR OTHER SPECIFIC REQUIREMENTS. DEVICE PLATES SHALL BE SELECTED BY OWNER, COLOR AND STYLE

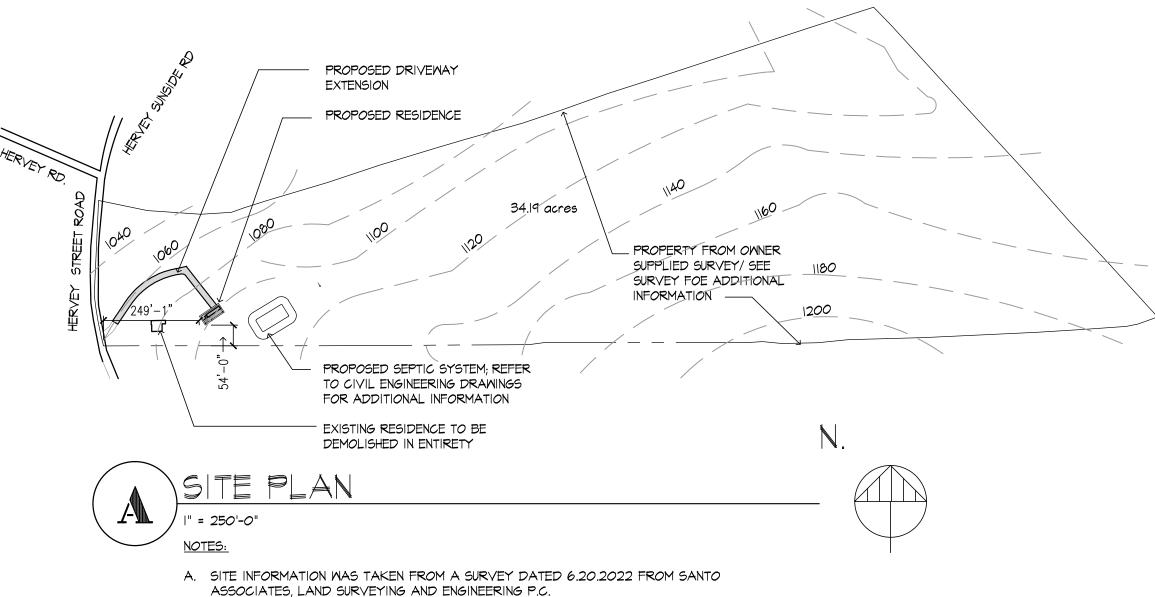

B. G.C. TO REFER TO CIVIL DRAWINGS FOR ADDITIONAL INFORMATION

CONSTRUCTION LEGEND

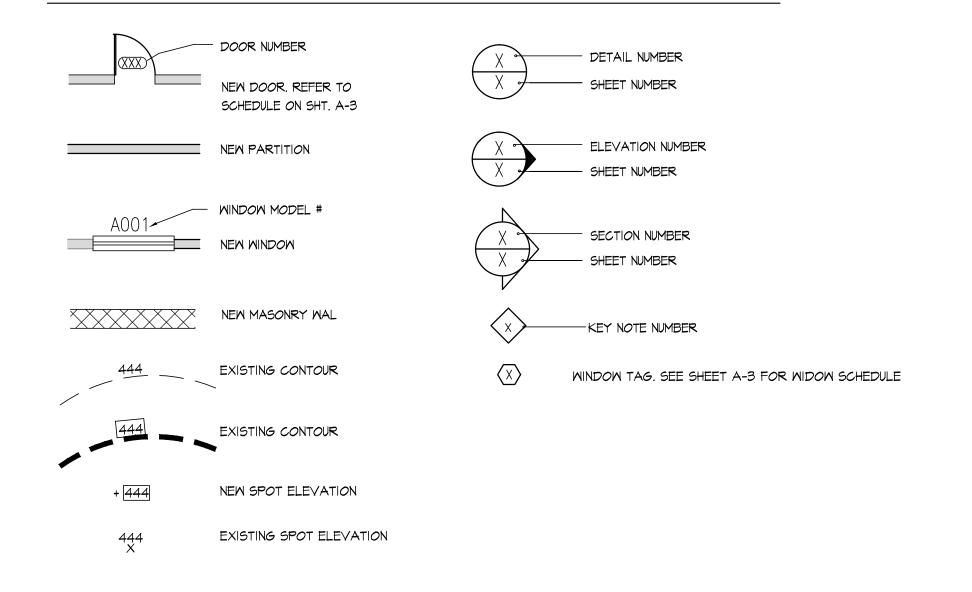

LIST OF DRAMINGS

TITLE SHEET, GENERAL NOTES, PLOT PLAN

A-2 FOUNDATION PLAN, DETAILS

FRAMING PLANS

A-3 FLOOR PLANS

ROOF PLANS, WALL SECTIONS

ELEVATIONS

POWER PLANS

A-8 RISER DIAGRAMS

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NEW YORK STATE

drawing title :

SITE PLAN GENERAL NOTES

revisions/issue


10/23/2023- ISSUE FOR BID


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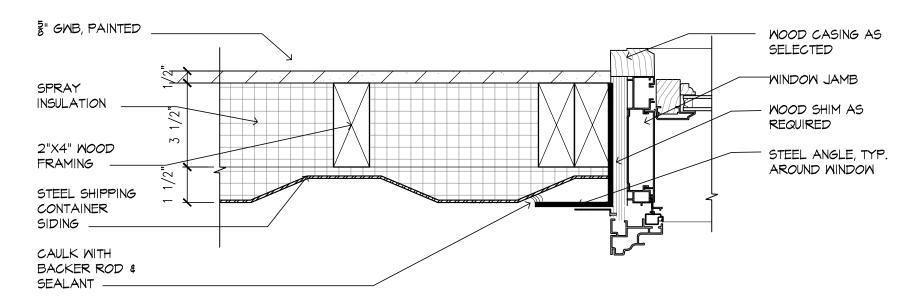
project no. : 3218

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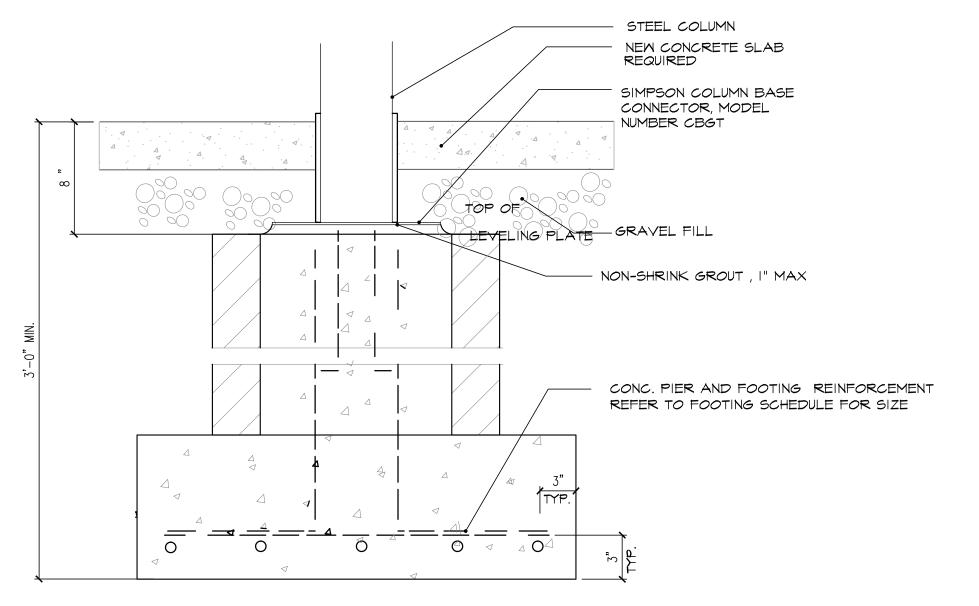
checked by:





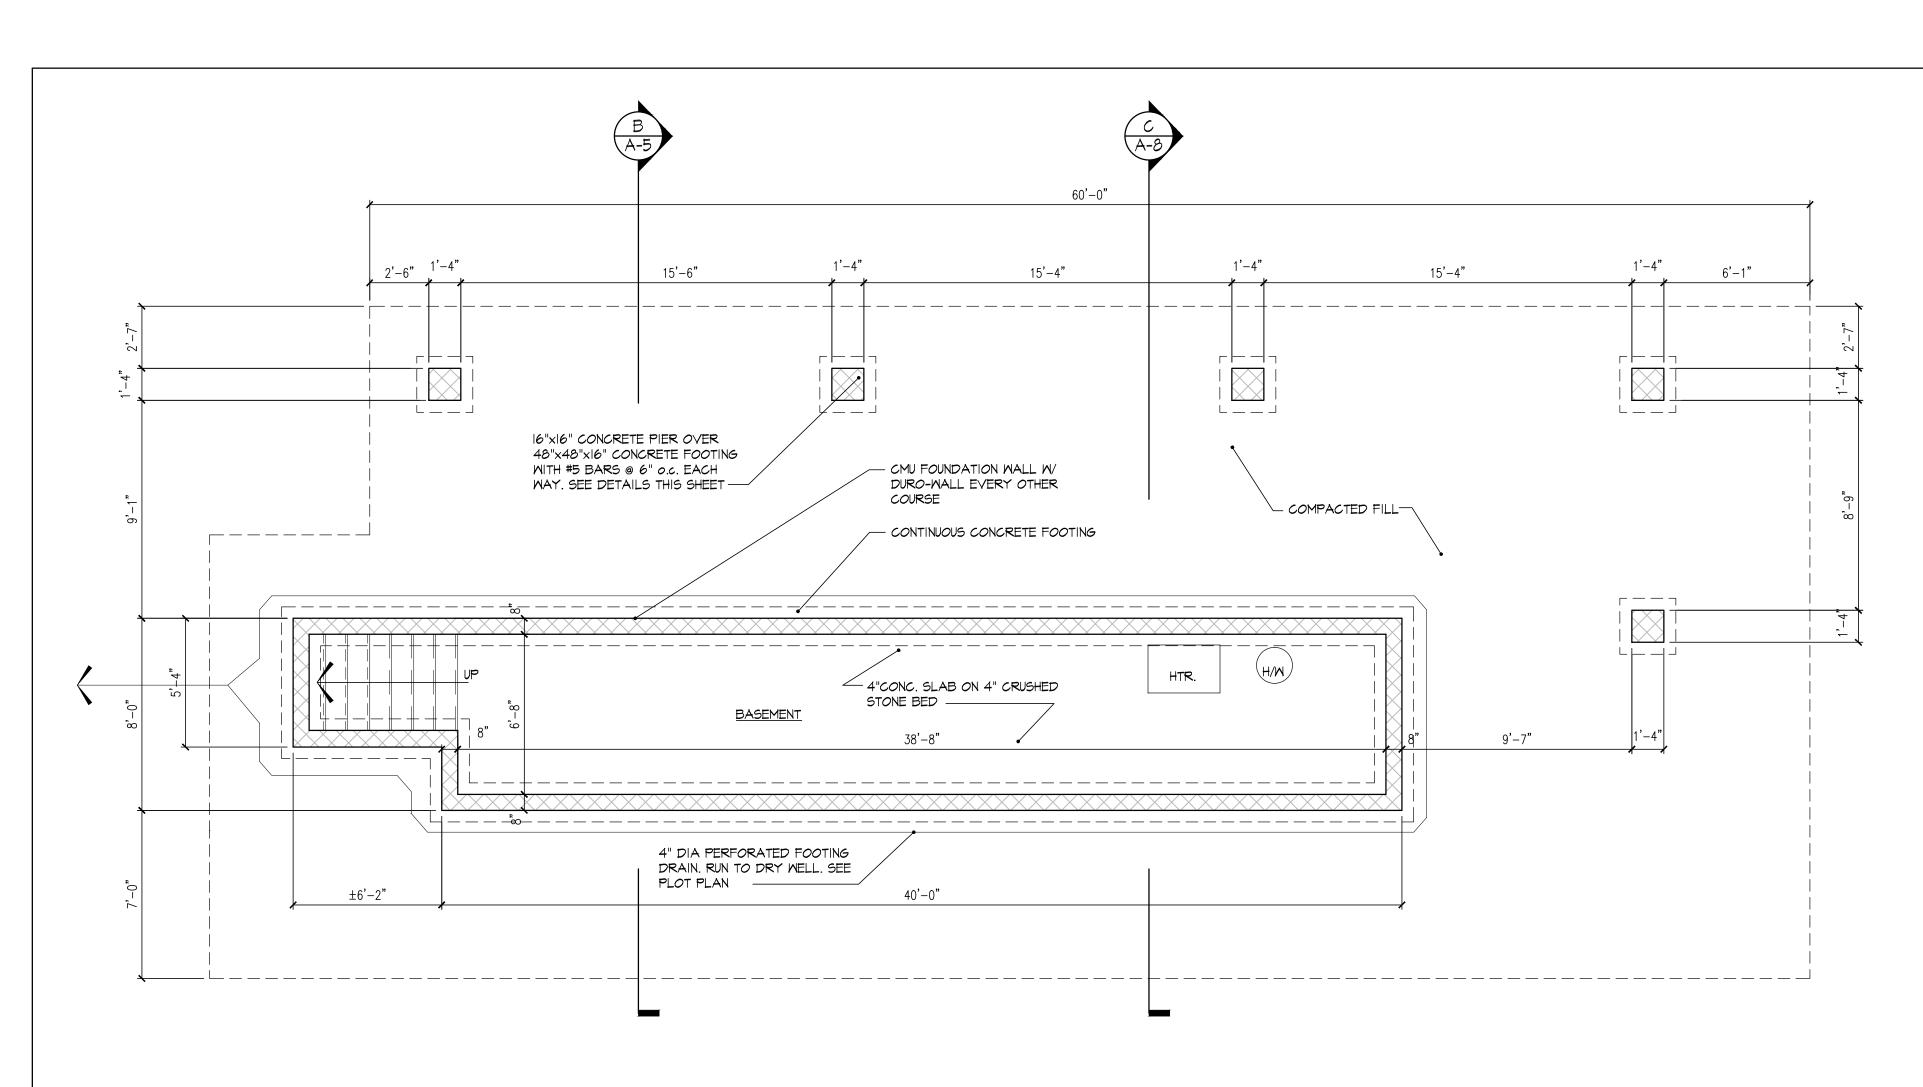

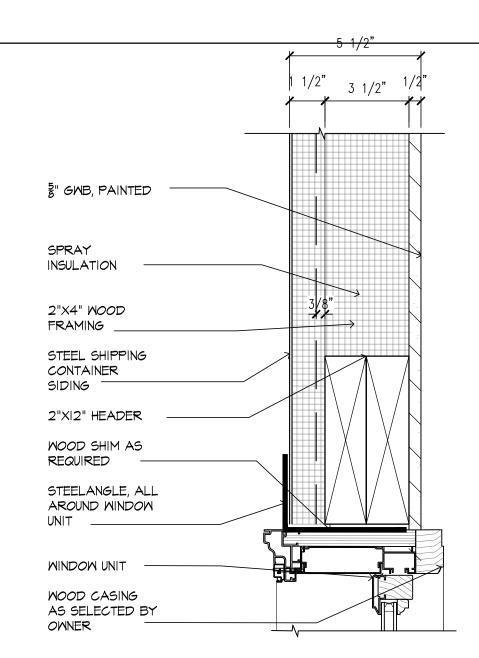







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FOUNDATION PLAN DETAILS

revisions/issue :

.) 10/23/2023- ISSUE FOR BID

drawn by: AR

checked by: RD

project no.: 3218

10/23/2023 date :

valid if sealed

sheet no.

CONTRACTOR'S NOTE:

G.C. MAY USE SYNTHETIC FIBER: FIBRILLATED OR MONOFILAMENT POLYPROPYLENE FIBERS ENGINEERED AND DESIGNED FOR USE IN CONCRETE, COMPLYING WITH ASTM C 1116, TYPE 111, 1/2 TO 1-1/2 INCHES


LONG. IN LEUI OF W.W.M.


MANUFACUTRES IS AS FOLLOWS:

A. FIBRASOL F; AXIM CONCRETE TECHNOLOGIES.

B. FIBERMESH, FIBERMESH, DIV. OF SYNTHETIC INDUSTRIES.


C. FORTA; FORTA CORPORATION. D. GRACE FIBERS; W. R. GRACE \$ CO., CONSTRUCTION PRODUCTS DIV.

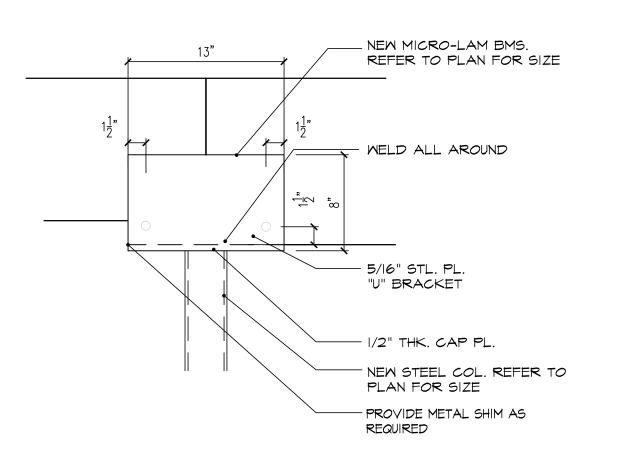

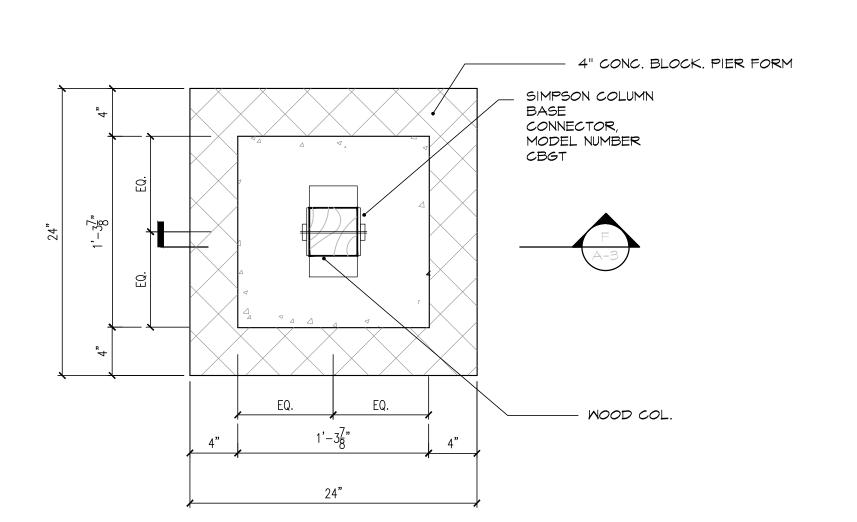






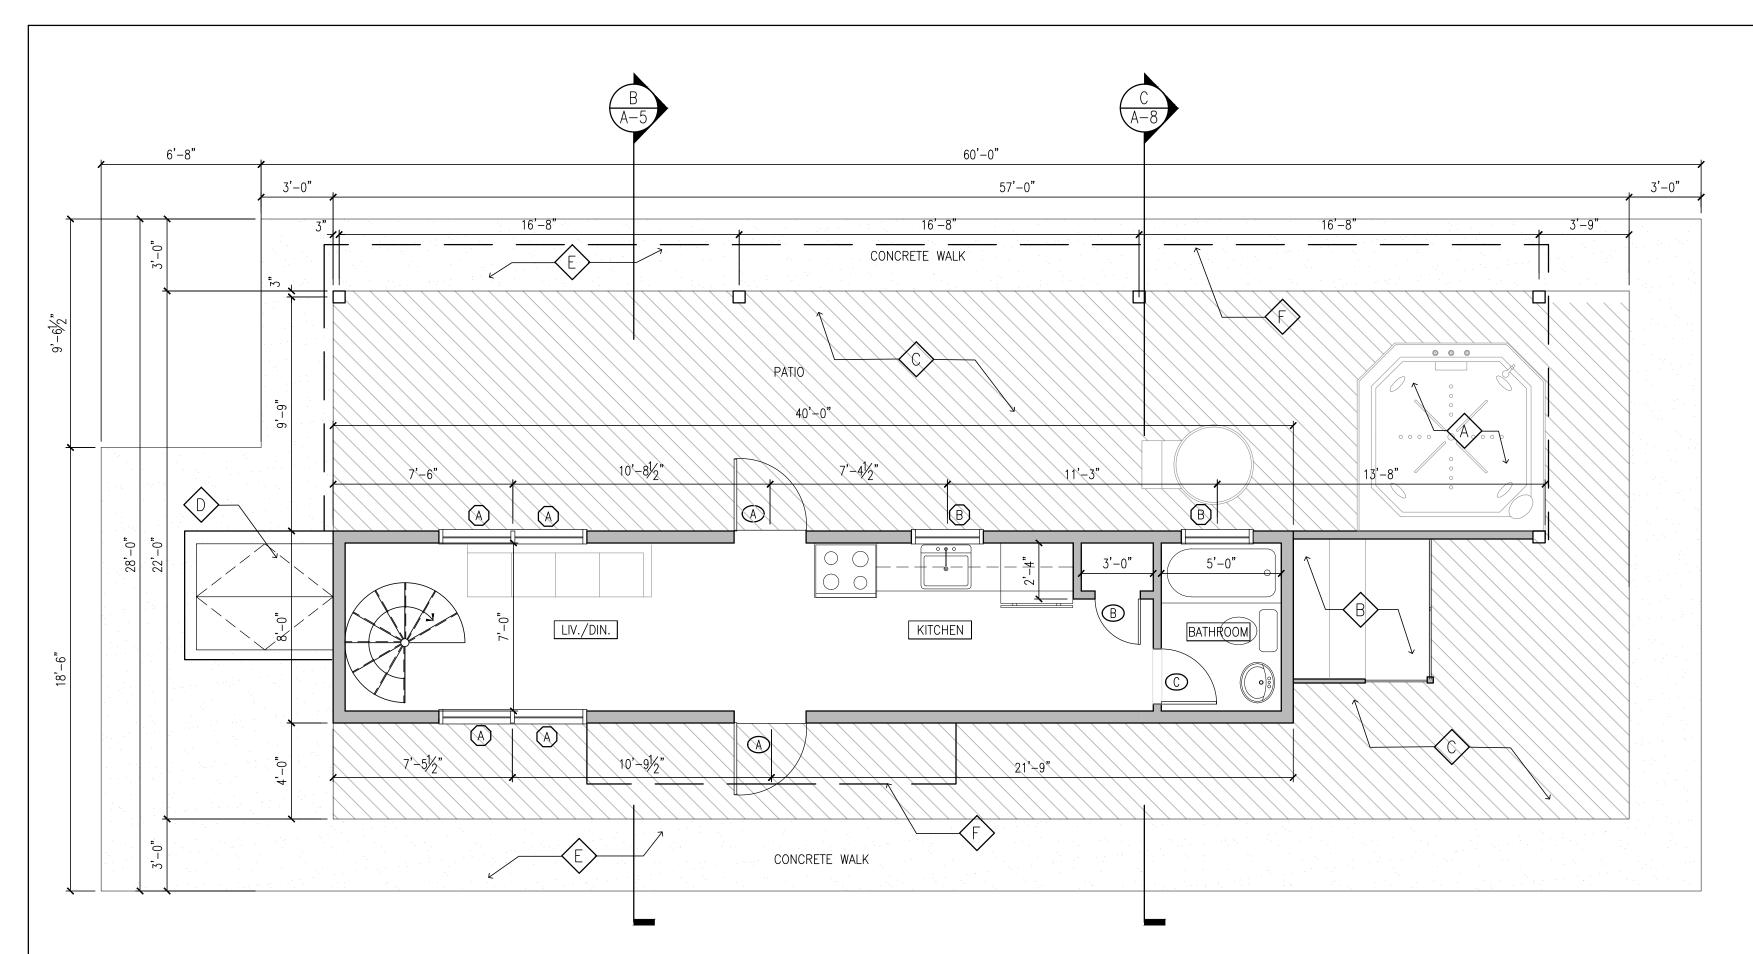

GROUND FLOOR CONSTRUCTION PLAN

1/4" = 1'-0"

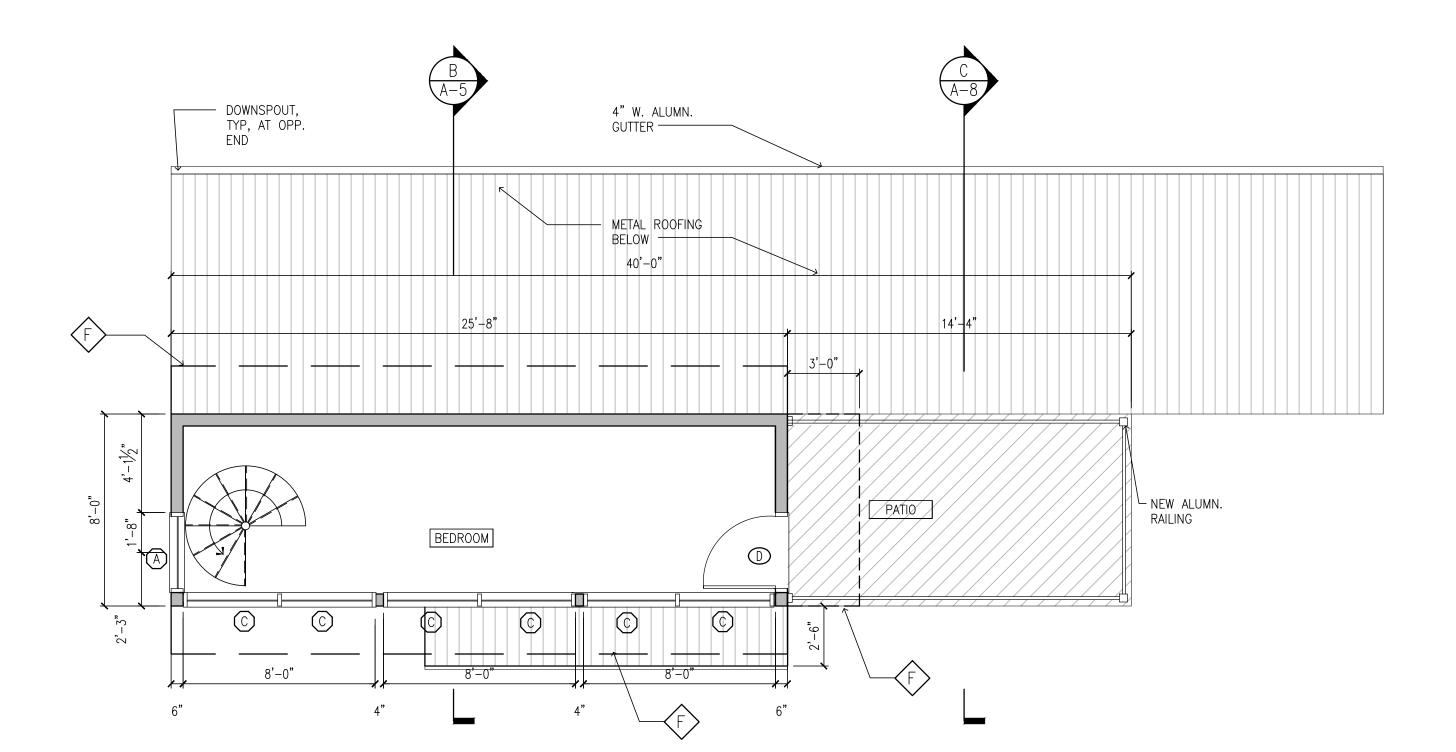

SECOND FLOOR CONSTRUCTION PLAN

1/4" = 1'-0"

DOOR SCHEDULE:

DOOR No.	SIZE			REMARKS		
	MIDTH	HEIGHT	THICK.	REMARKS		
A	3'-0"	7'-0"	-	THERMA TRU FIBERGLASS EXTERIOR DOOR. FINAL SELECTION B.O. DOOR.		
В	2'-0"	7'-0"	3/4"	SIX PANEL, SOLID PINE WD.		
O	2'-8"	7'-0"	3/4"	SIX PANEL, SOLID PINE WD.		
D	3'-0"	7'-0"	-	ANDERSON 400 SERIES FRENCHWOOD DOOR MODEL # FWH3180AL		

MINDON SCHEDULE:

"ANDERSON" - 400 SERIES (UNLESS OTHERWISE NOTED)

TYPE	ROUGH OPENING SIZE		MODEL NUMBER	NOTES				
IIFL	MIDTH	HEIGHT	MODEL NUMBER	NOTES				
А	3-0 ½"	6'-0 g"	CXMI6	xxx				
В	2-4 7 "	6'-0 g"	CMI4	xxx				
C	4-0 ½"	6'-0 g"	P4060	xxx				

I. GC TO VERIFY EXISTING MASONRY OPENING SIZE.

2. GC TO MODIFY EXISTING WINDOW OPENING AS REQUIRED TO ACCOMMODATE TO WINDOW UNIT. PROVIDE NEW HEADER AS REQUIRED.

KEY NOTES

A. NEW HOT TUB SUPPLIED BY OWNER

B. NEW SUANA; TO BE SUPPLIED AND INSTALLED BY OWNER

C. NEW WOOD PLANKING; SEE SECTION

D. NEW CELLAR ACCESS DOORS BY BILCO OR APPROVED EQUAL

E. NEW CONCRETE WALK

F. LINE OF OVERHANG ABOVE

project title :

NEW RESIDENCE AT

THE DEROSA GROUP, PC

Architects

Tel: 973.624.1100 Fax: 973.624.2426

45 Academy Street Suite 202 Newark, New Jersey 07102

268 HERVEY ST.

TOWN OF DURHAM
GREENE COUNTY
NEW YORK STATE


drawing title :

FLOOR PLANS

revisions/issue :

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268 HERVEY ST

TOWN OF DURHAM GREENE COUNTY NEW YORK STATE

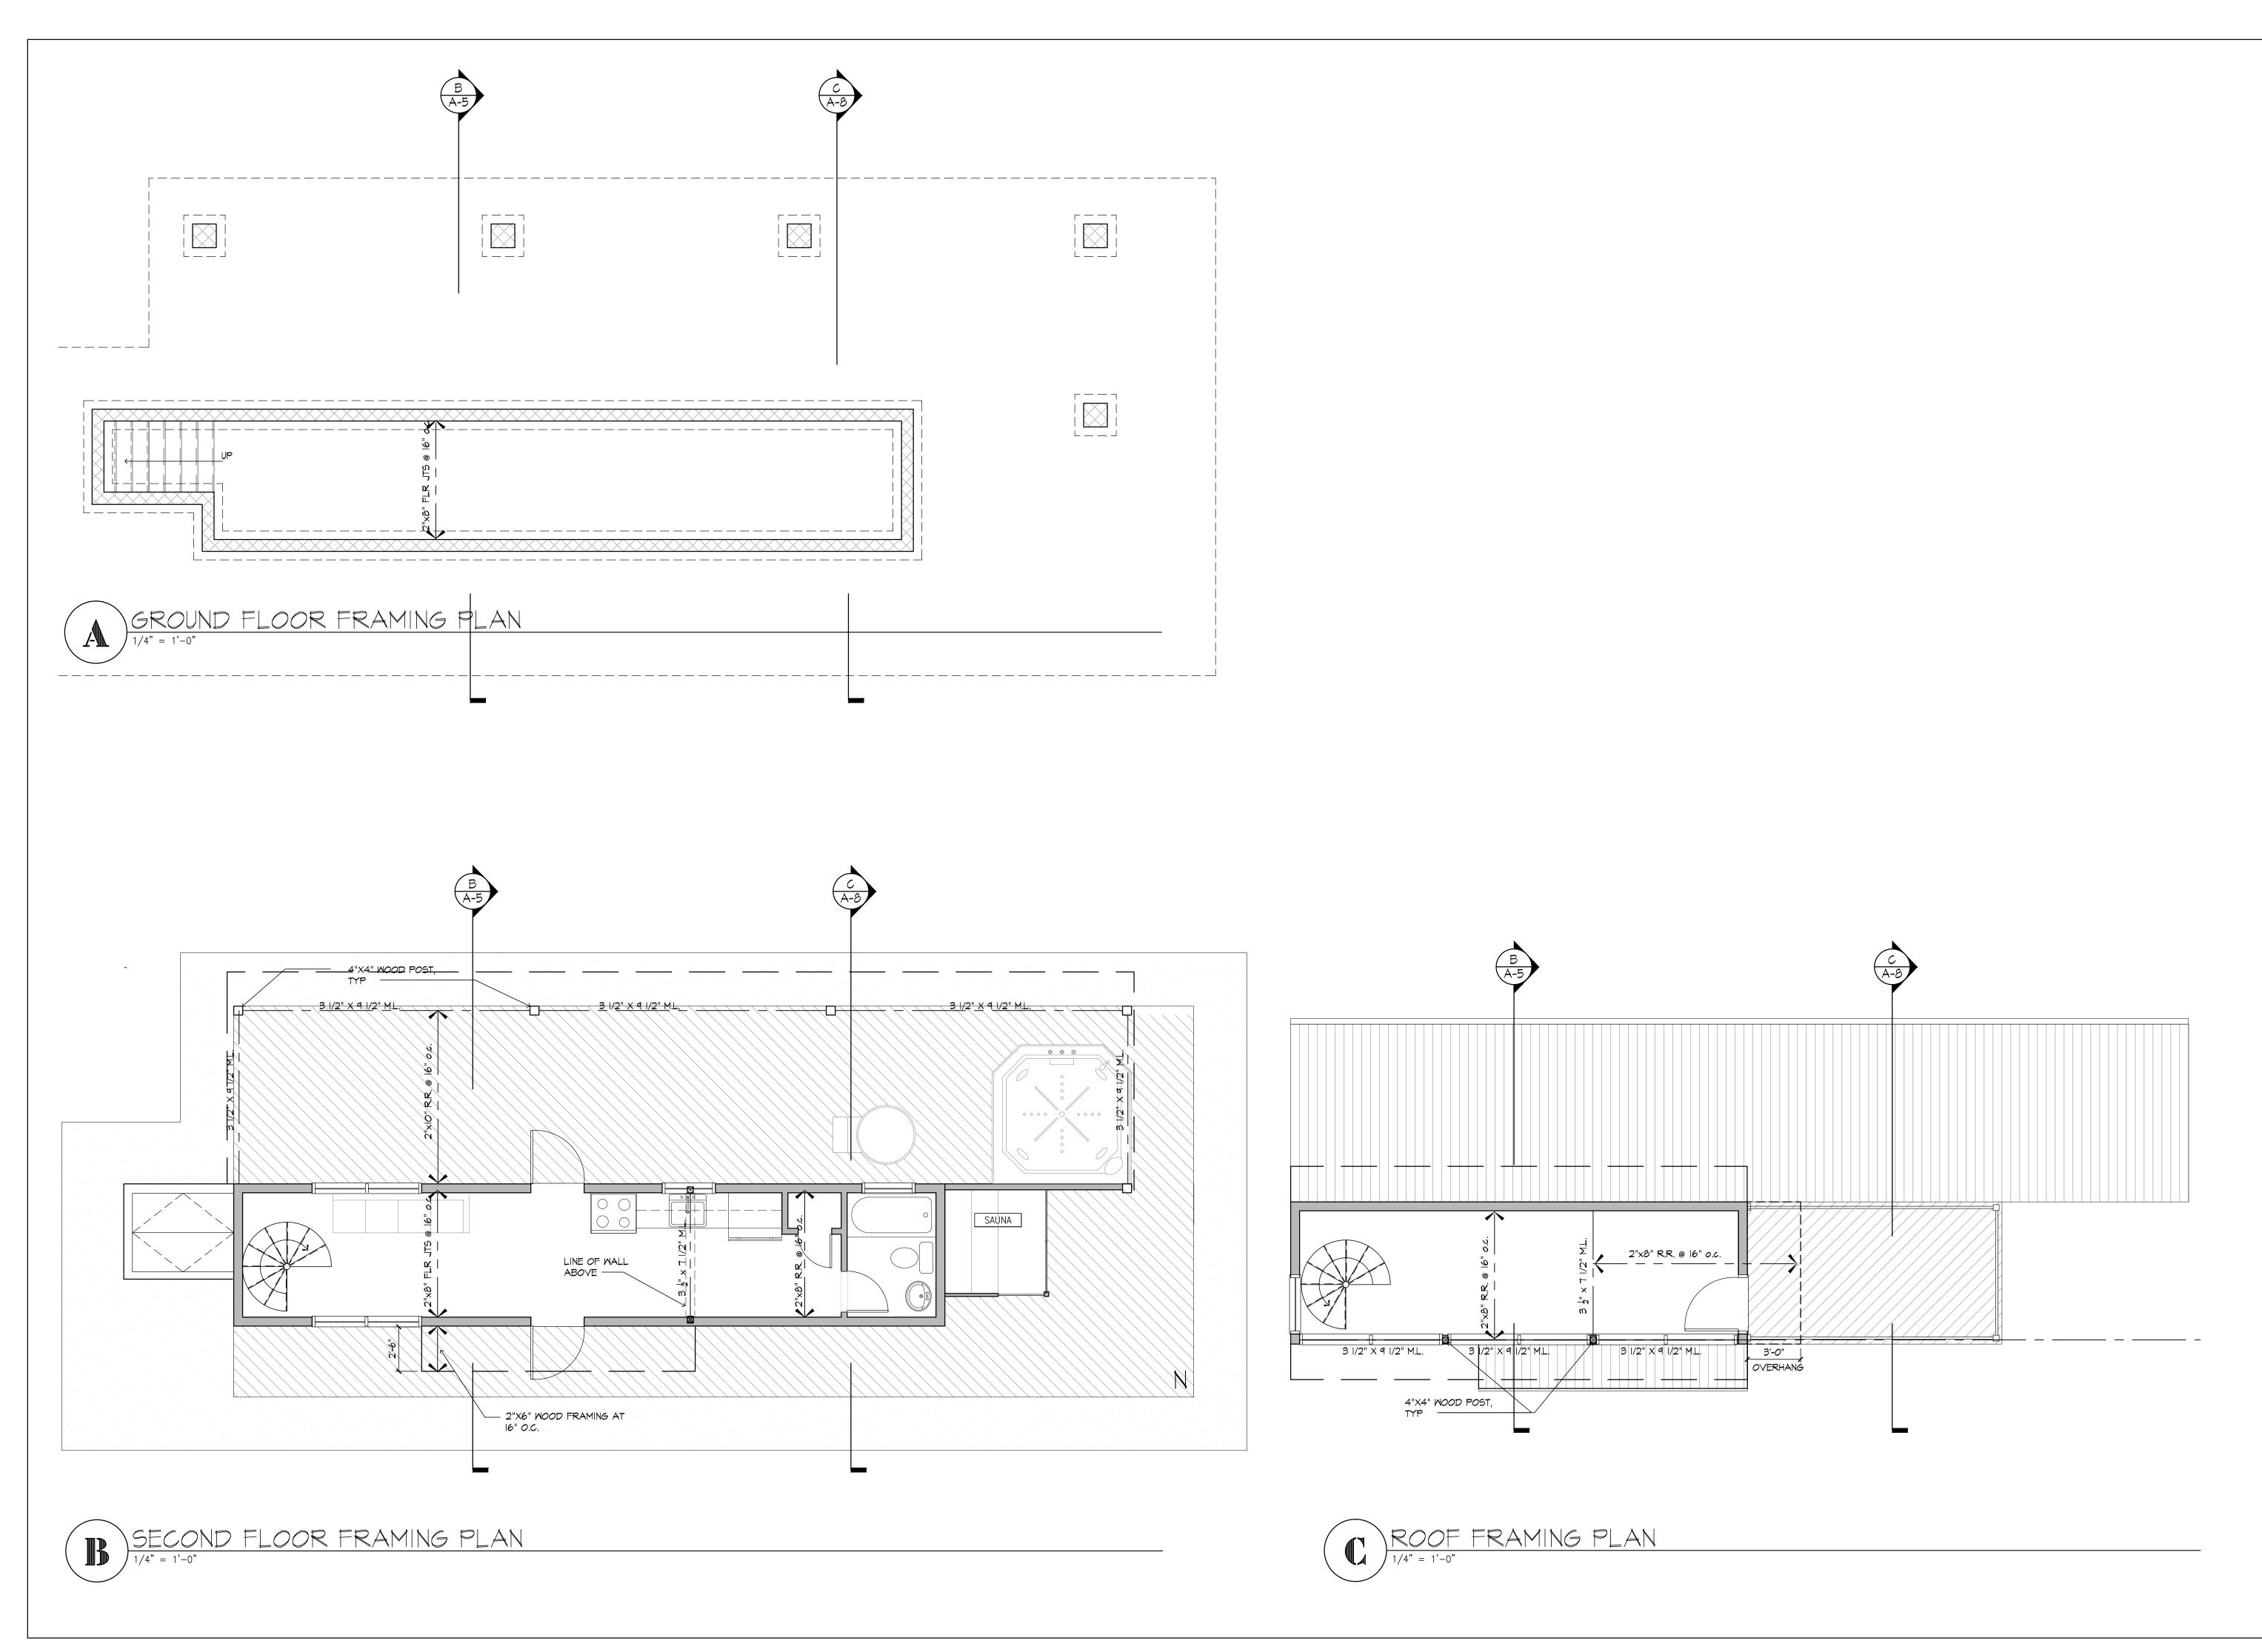drawing title :

FRAMING PLANS

revisions/issue :

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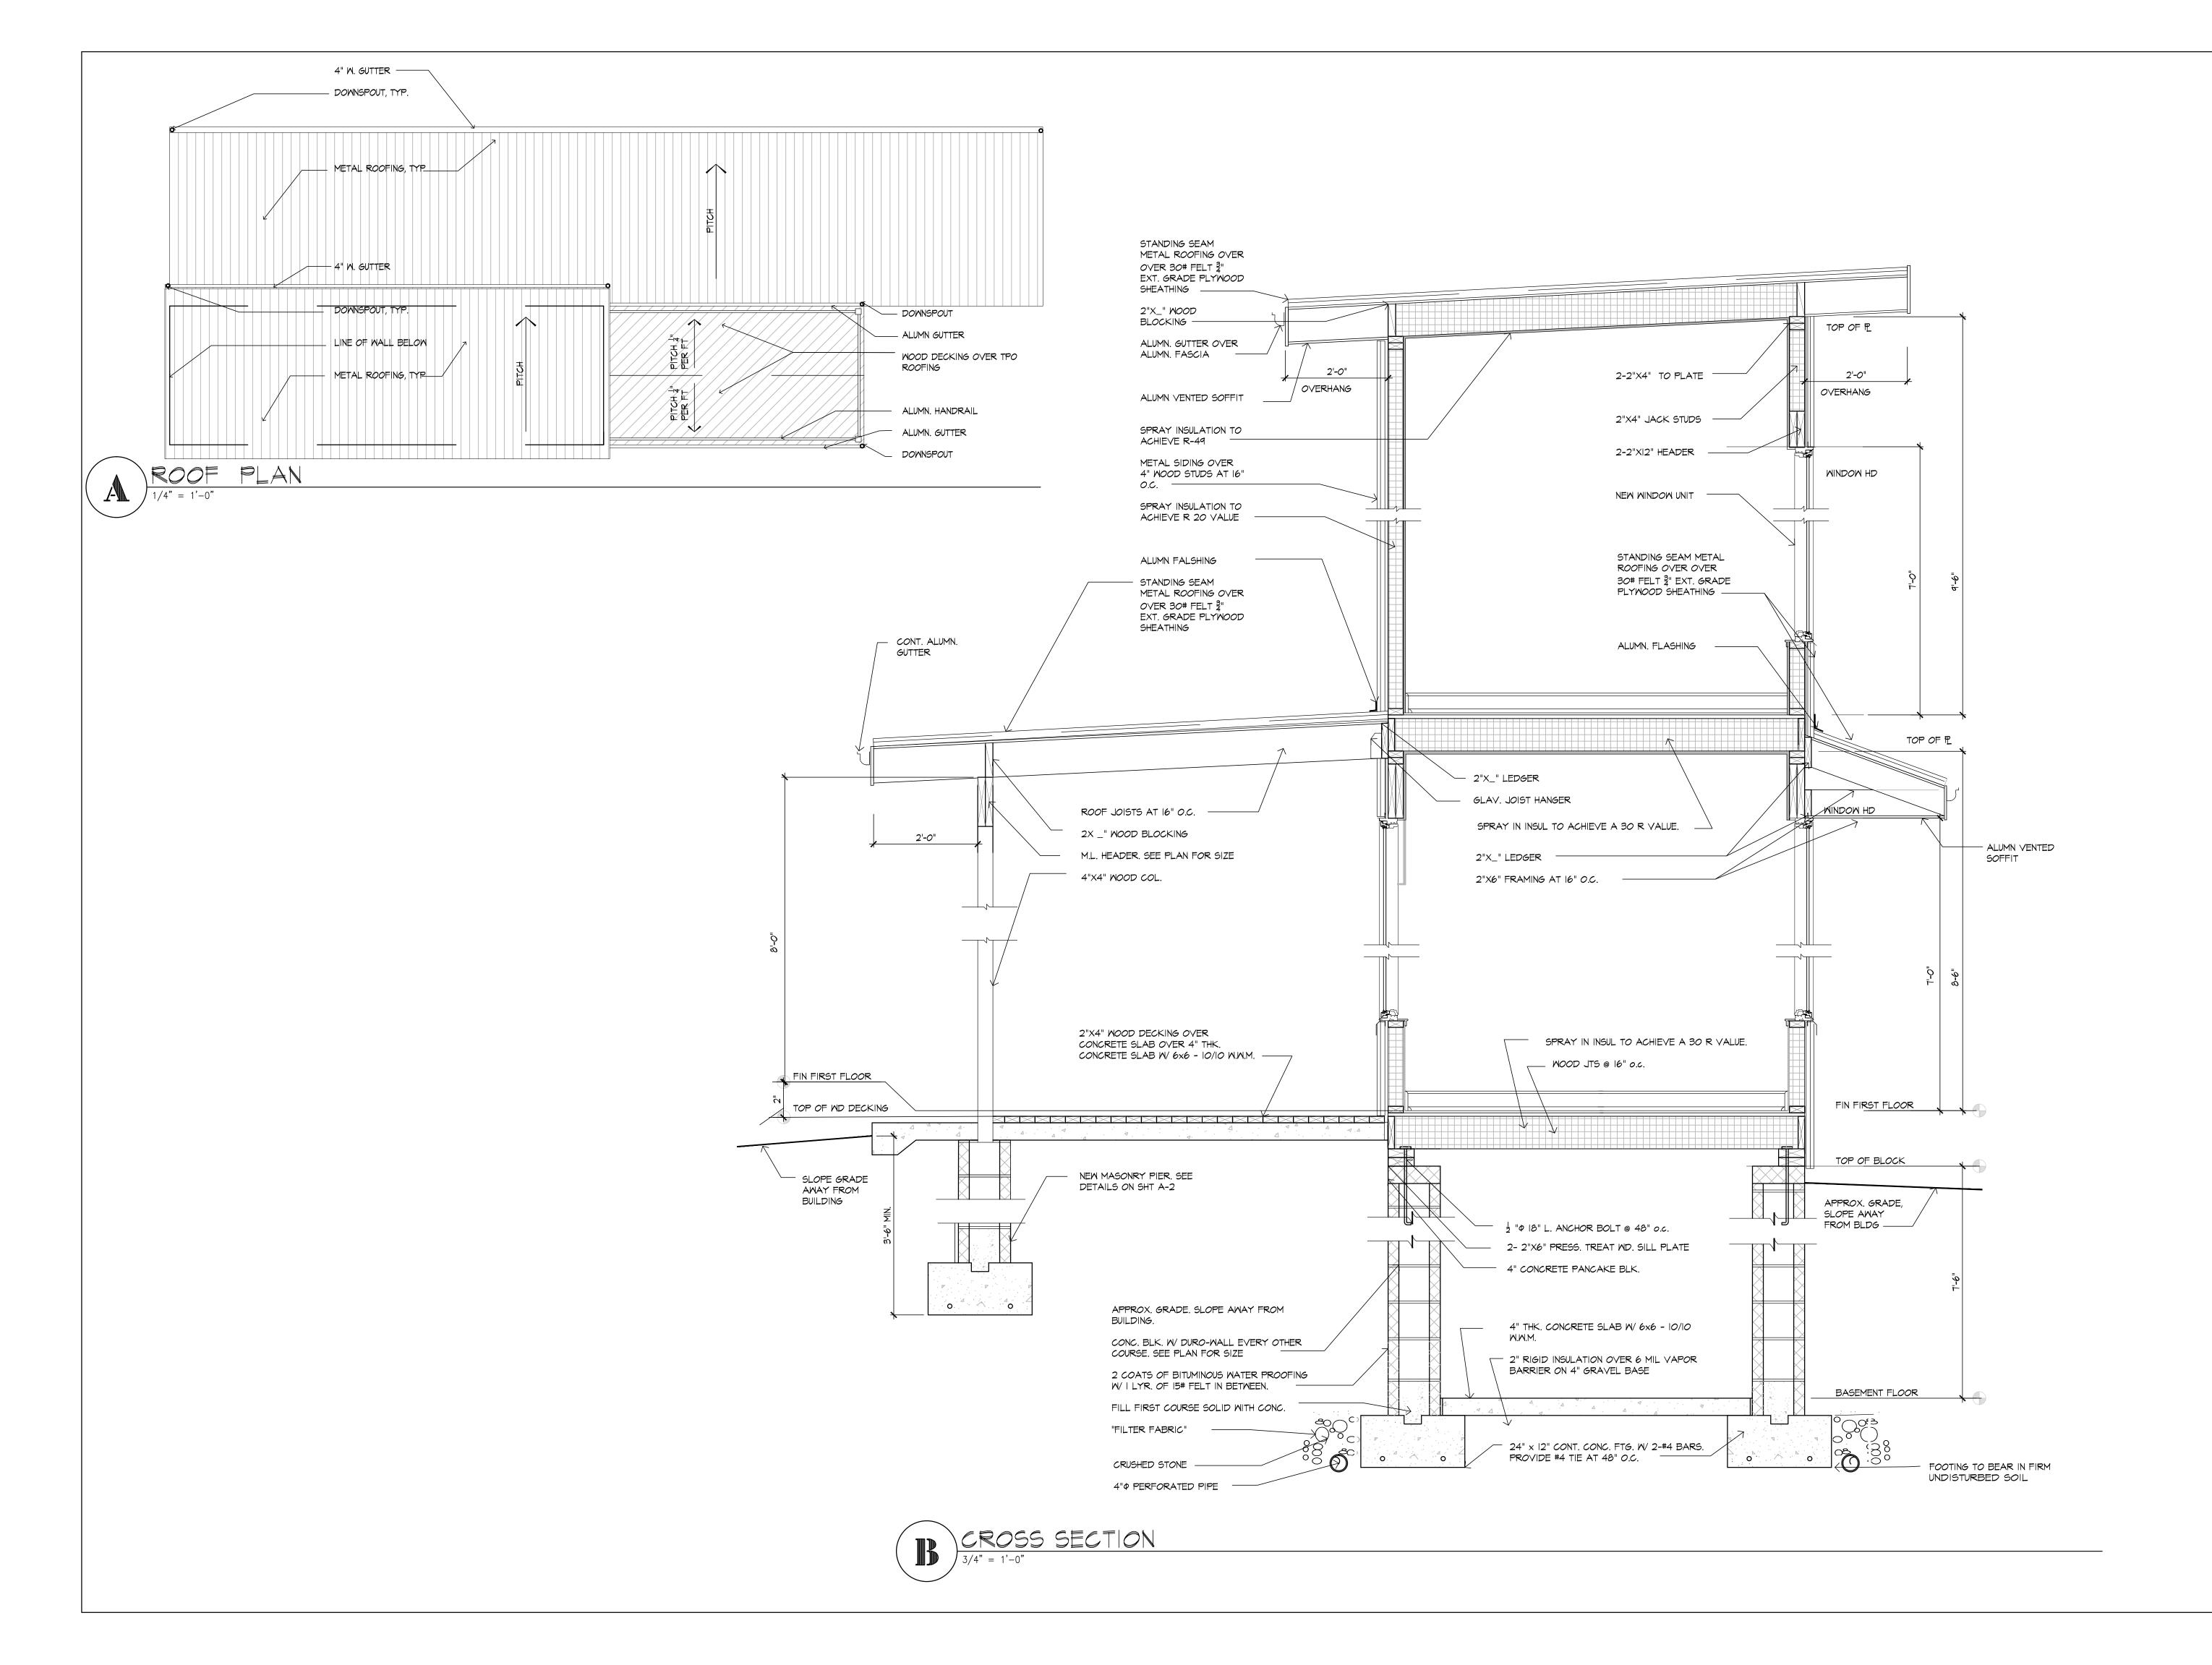
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drawing title :

ROOF PLAN CROSS SECTIONS

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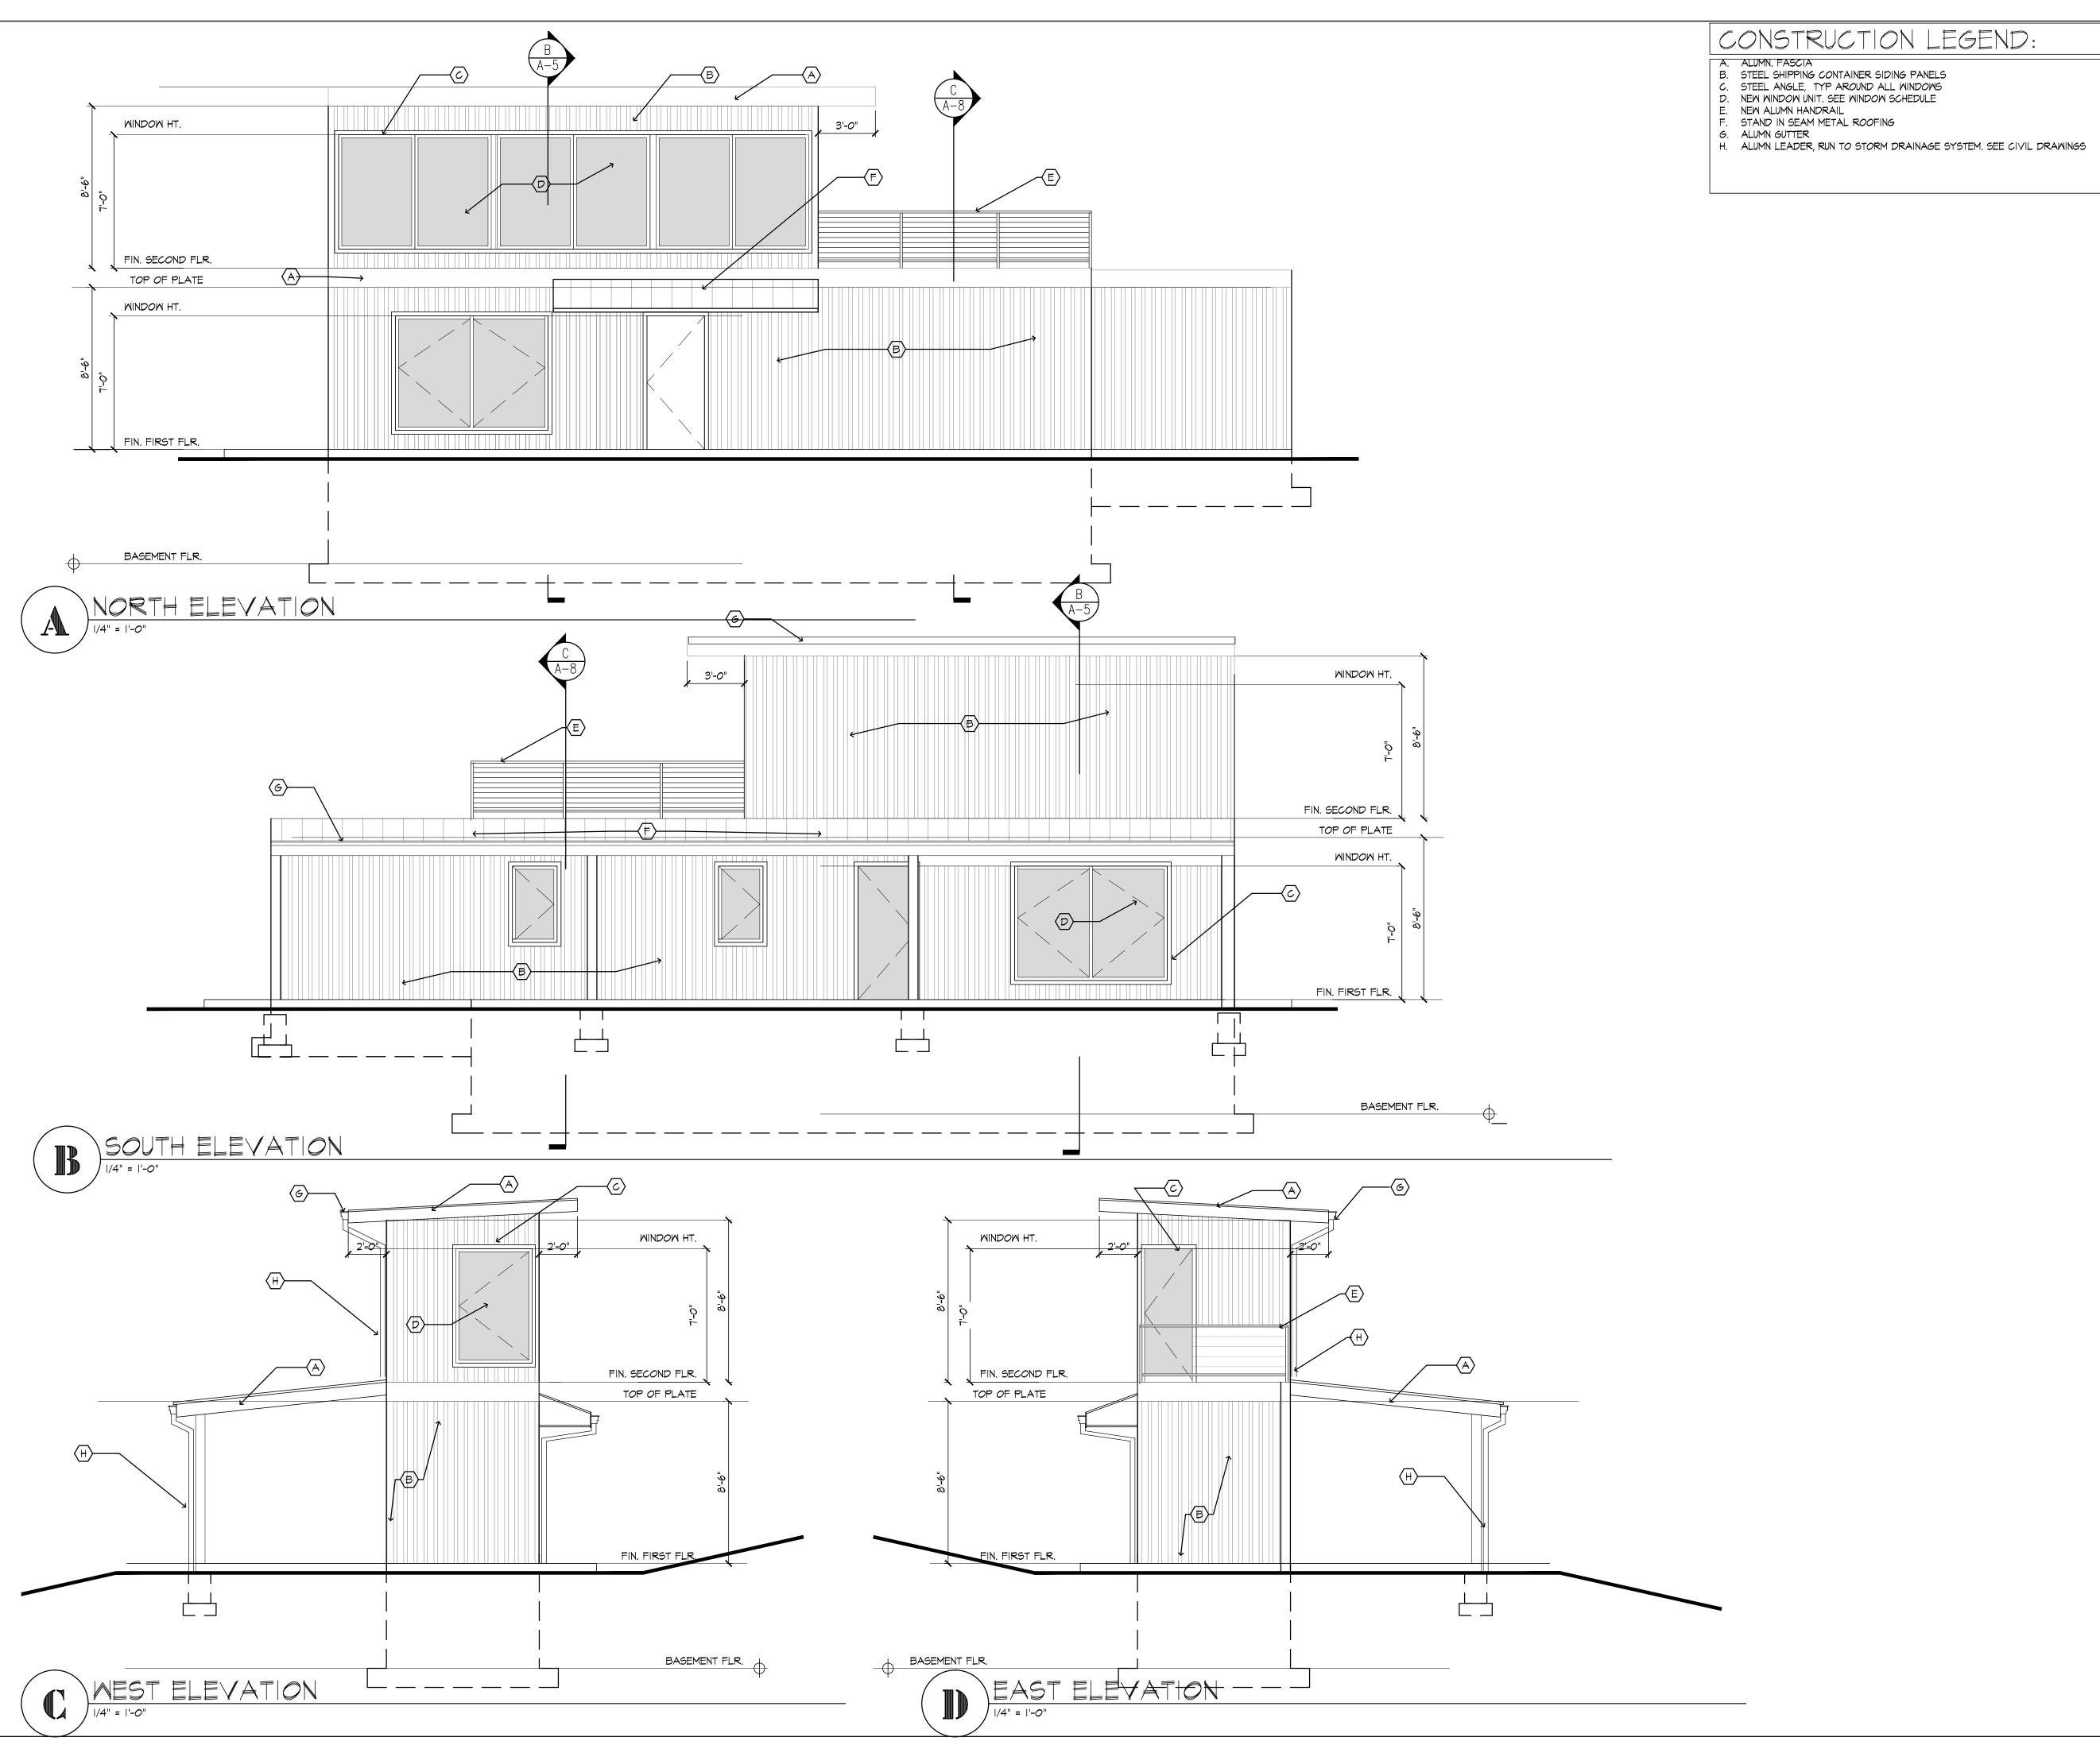
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CONSTRUCTION LEGEND:

- A. ALUMN. FASCIA

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project title :

NEW RESIDENCE AT

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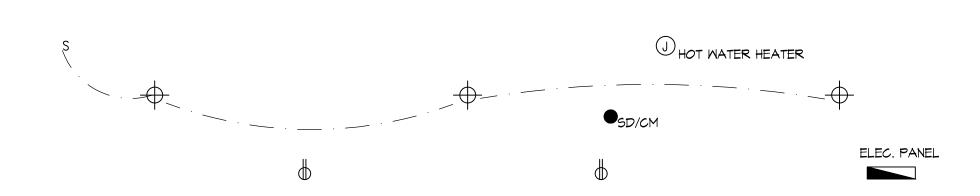
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revisions/issue :


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BASEMENT ELECTRICAL PLAN 1/4" = 1'-0"



GROUND FLOOR ELECTRICAL PLAN

ELECTRICAL LEGEND

4" RECESSED LED DOWNLIGHT. 12W, 12OV, 5000K COLOR TEMP MAX. RATED FOR EXTERIOR USE

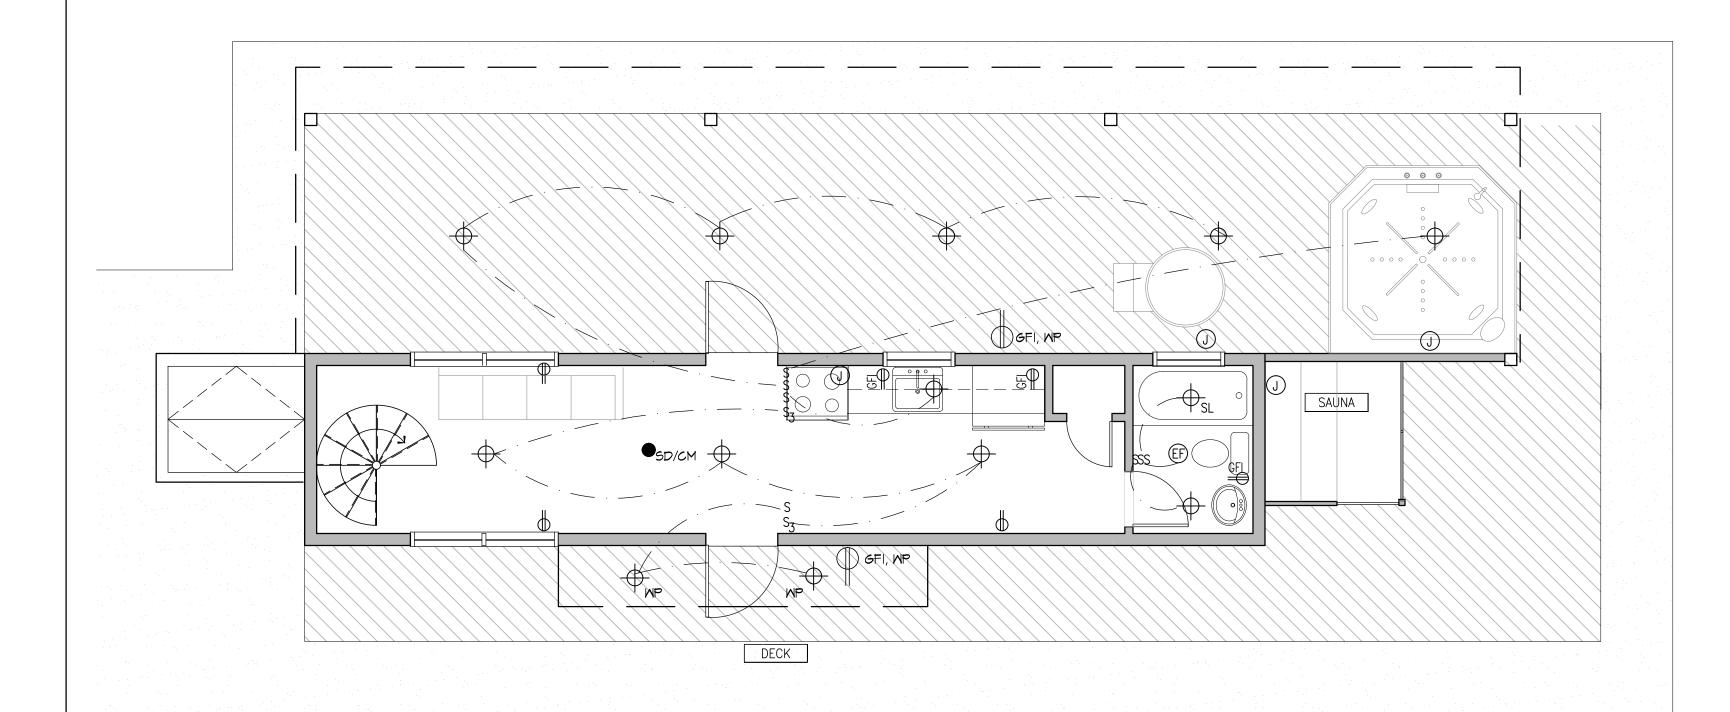4" RECESSED LED DOWNLIGHT. 12M, 12OV, 5000K COLOR TEMP MAX. PROVIDE SLOPED TRIM FOR FIXTURES INSTALLED IN SLOPED CEILINGS.

RECESSED INCANDESCENT SHOWER LIGHT.

SURFACE MOUNTED LED WALL LIGHT. EXTERIOR FIXTURES TO BE RATED FOR WET

LED WALL SCONCE. MOUNT BOTTOM OF SCONCE 7'-O" A.F.F.

EXHAUST FAN, REFER TO GENERAL NOTES FOR SIZE

DUAL LED LAMP ADJUSTABLE FLOODLIGHT, W. MOTION SENSOR 1900 LUMENS - 20W - 3000 K

NOTE: ALL RECESSED LIGHTING FIXTURES INSTALLED IN INSULATED CEILINGS SHALL BE

LOCATION FOR T.V AND TELEPHONE OUTLETS ARE FOR INFORMATION PURPOSES ONLY.

DUPLEX ELECTRICAL RECEPTACLE

DUPLEX ELECTRICAL RECEPTACLE, GROUND FAULT PROTECTED

DUPLEX ELECTRICAL RECEPTACLE, GROUND FAULT PROTECTED, WET LOCATION

TOGGLE SWITCH

TOGGLE SMITCH, 3-MAY

DIMMER SWITCH DIMMER SWITCH, 3-WAY

OSD/CM COMBINATION SMOKE DETECTOR & CARBON MONOXIDE DETECTOR

DATA PORT

JUNCTION BOX

E ELECTRIC METER

-PCF CEILING FAN

- INDIRECT LIGHTING ON CABINETS

VERIFY FINAL LOCATION IN FIELD WITH OWNER.

DISCONNECT SWITCH FOR

CONDENSING UNTIS

HOME AUTOMATION


RATED FOR DIRECT CONTACT WITH INSULATION

G.C. TO PROVIDE NEW SECURITY/HOME COMMUNICATION SYSTEM BY AI-PHONE; JF SERIES OR OWNER APPROVED EQUAL.

EXHAUST FAN SCHEDULE

BATHROOM: I.) 100 C.F.M.

REFER TO GENERAL NOTES FOR ADDITIONAL INFORMATION

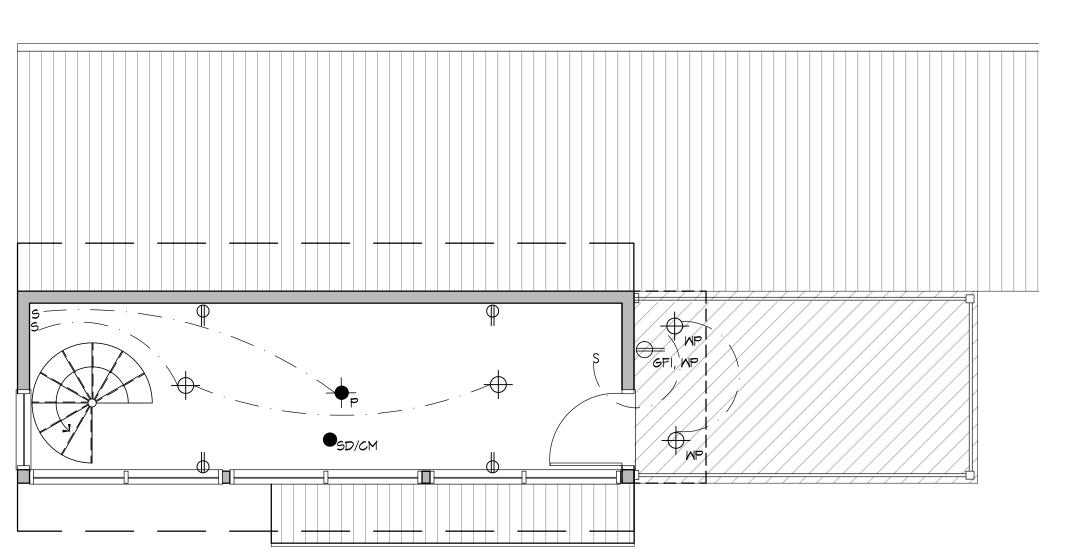

SECOND FLOOR ELECTRICAL PLAN

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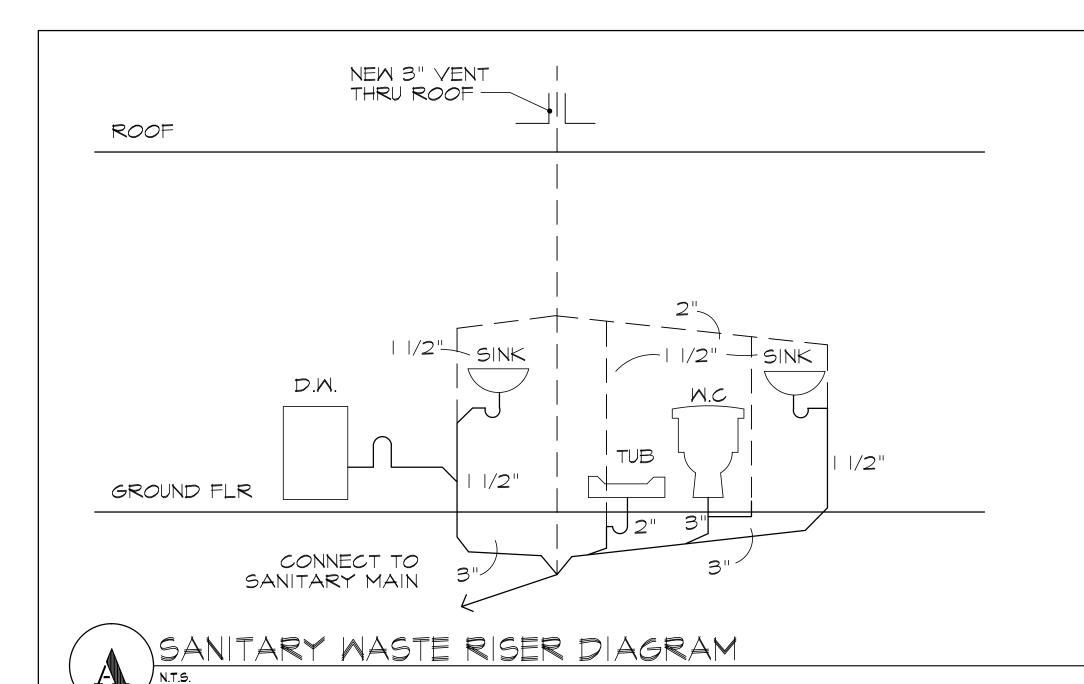
TOWN OF DURHAM GREENE COUNTY NEW YORK STATE

drawing title :

ELECTRICAL PLANS


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DOMESTIC MATER SUPPLY RISER DIAGRAM

N.T.S.



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project title :

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drawing title :

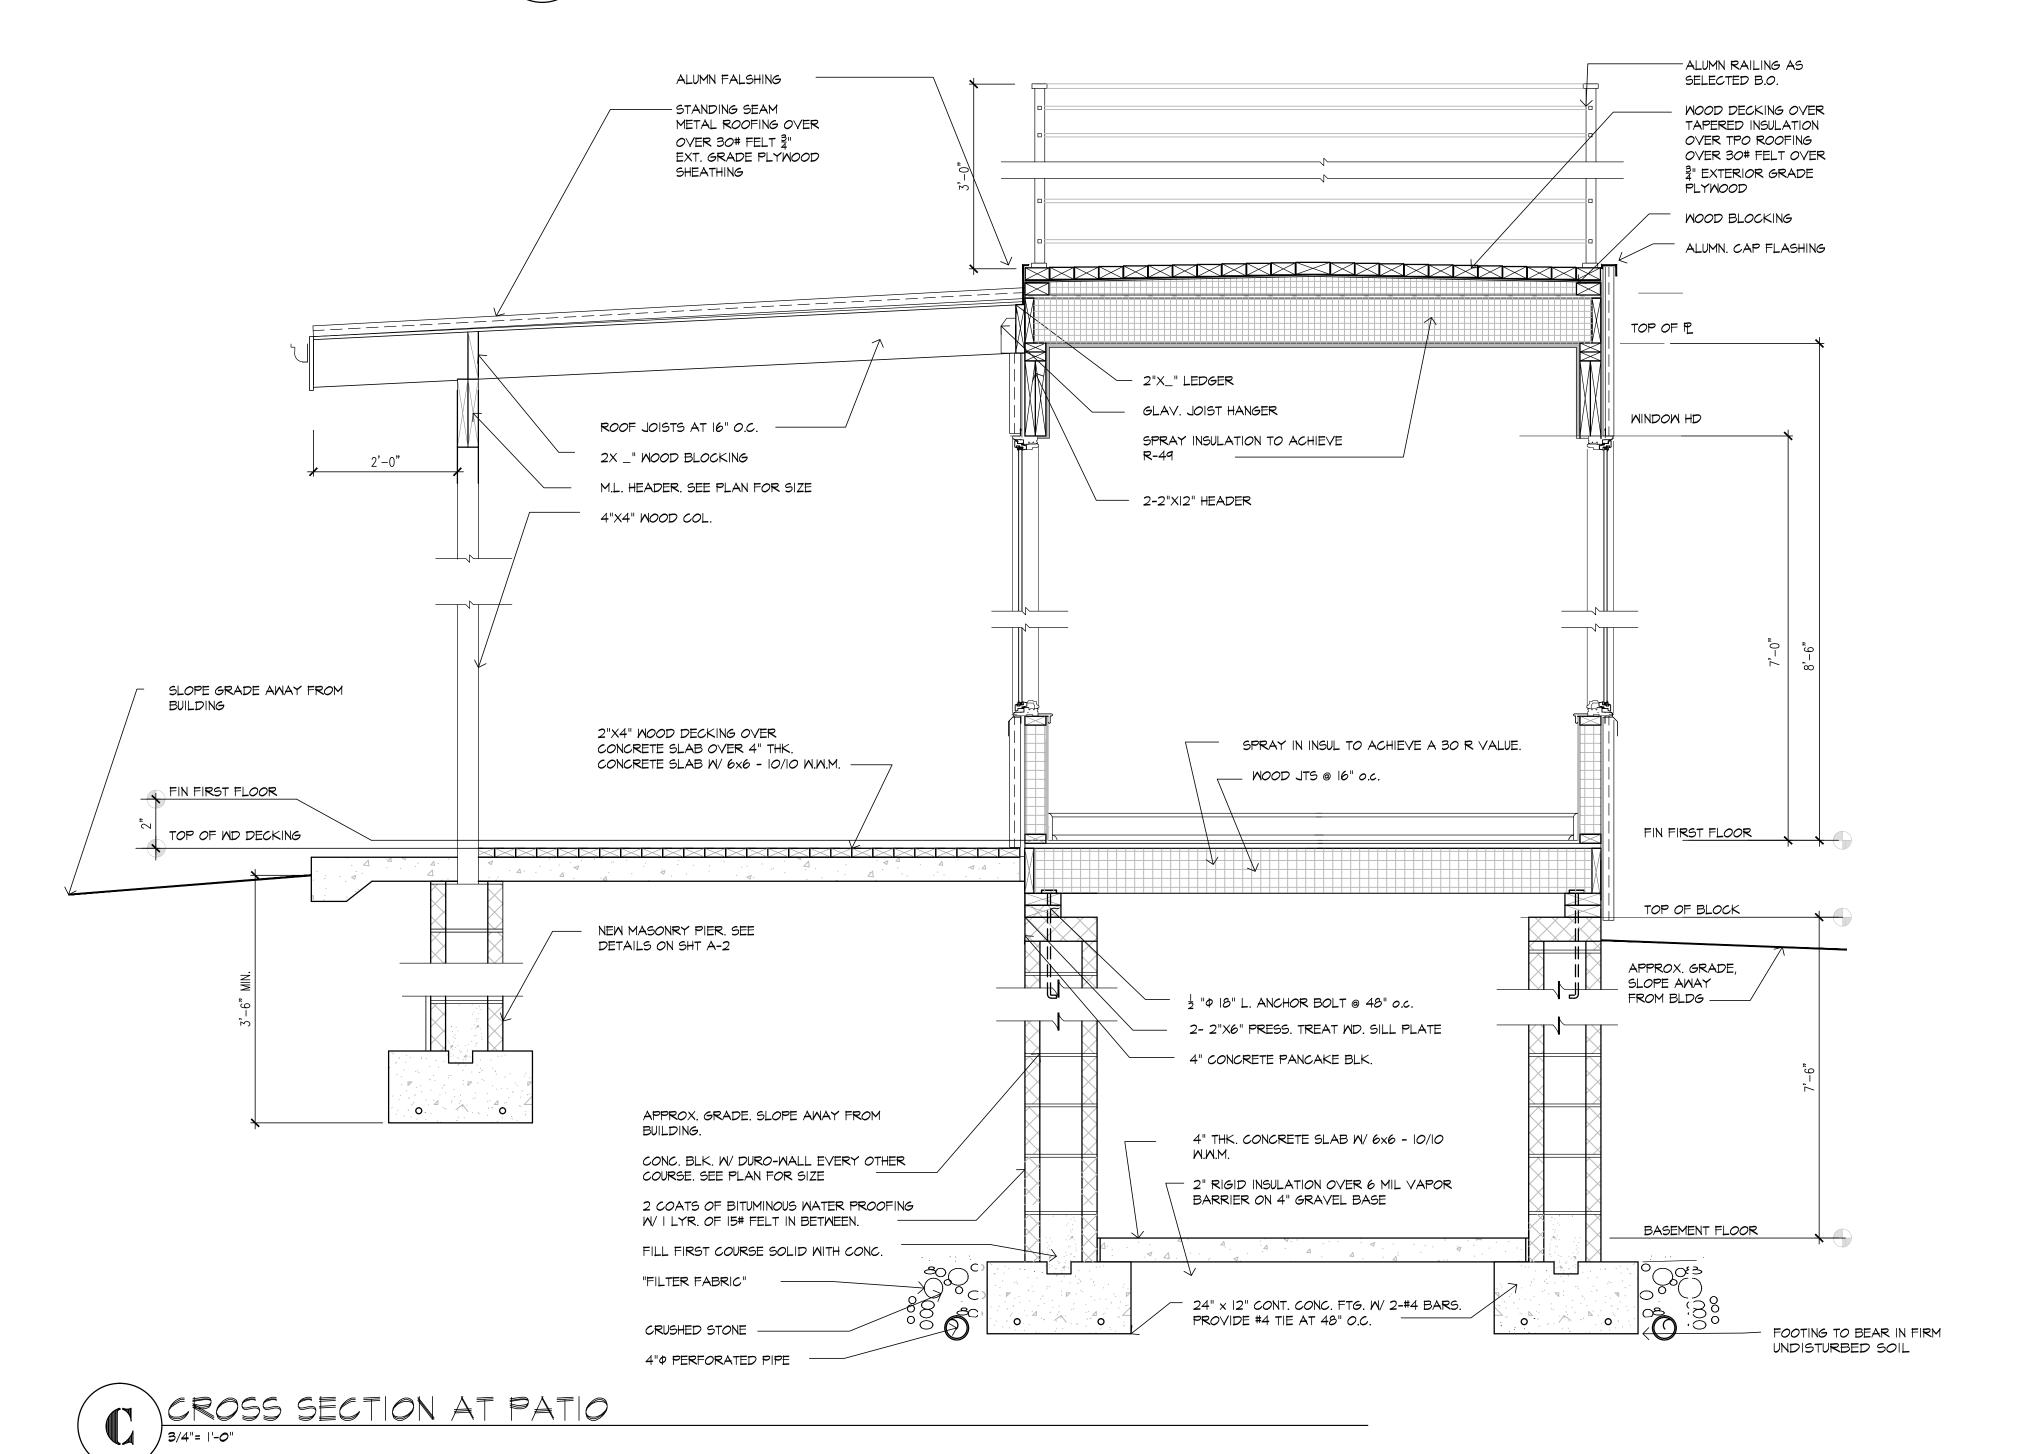RISER DIAGRAMS

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